DAWSON COUNTY REZONING APPLICATION

This portion to be completed by Zoning Administrator

ZA SU 21-07		Tax Map &	Parcel # (TMP): <u>049 001</u>	
Submittal Date: <u>10/8/2021</u>	Time:	ar	n/pm Received by: hg	(staff initials)
Fees Assessed:	Paid:		Commission District:	
Planning Commission Meeting I	Date: November	16, 2021		
Board of Commissioners Meetin	g Date: <u>Decemb</u>	per 16, 2021		
APPLICANT INFORMA	ΓΙΟΝ (or Auth	orized Represe	ntative)	
Printed Name: Greg Sper	ce			
Address:				
Phone: Listed Unlisted		Email:	Business Personal	
Status: [] Owner [X] Autho			[] Option to purchase	
Notice: If applicant is other tha	n owner, enclos	sed Property O	wner Authorization form mus	st be completed.
I have X /have not pa	rticipated in a Pı	re-application r	meeting with Planning Staff.	
If not, I agree/disagree	to schedule	a meeting the	week following the submittal	deadline.
Meeting Date:	Applicant S	Signature:		
PROPERTY OWNER/PR	OPERTY IN	FORMATION	ON	
Name: Joyce S Hutcheson	1			
Street Address of Property being	rezoned: Pa	rcel ID# 049 0	01	
Rezoning from: Directions to Property (if no add				5 58.99
1 0	,		niles, right turn onto State Rt 3	342,
travel ~3.6 miles, turn right or	nto GA HWY-52	2. Site will be in	n wooded lot ~ 450ft on left	

Subdivision Name (if applicable):	Lot(s) #:
Current Use of Property: wooded	
	es, please provide rezoning case #: ZA
***Please refer to Dawson County's Georgia 400 Co	rridor Guidelines and Maps to answer the following:
Does the plan lie within the Georgia 400 Corridor?	lo (yes/no)
If yes, what section? North South	
SURROUNDING PROPERTY ZONING CLASSIF	ICATION:
North RA South RA	East RA West RA
Future Land Use Map Designation: RA	
Access to the development will be provided from: Road Name: Georgia Hwy 52	
REQUESTED ACTION & DETAILS OF PE	ROPOSED USE
[] Rezoning to: [X] Specia	l Use Permit for:Telecommunications Tower
Proposed Use: Applicant plans to install a 195ft total height monopo	ble tower for installation of antennas and equipment
Existing Utilities: [] Water [] Sewer [] Ga	as [] Electric
Proposed Utilities: [] Water [] Sewer [] G	as [] Electric
RESIDENTIAL	
No. of Lots: Minimum Lot Size:	(acres) No. of Units:
Minimum Heated Floor Area: sc	. ft. Density/Acre:
Type: [] Apartments [] Condominiums [] Tow	nhomes [] Single-family [] Other
Is an Amenity Area proposed:; if yes,	what?
COMMERCIAL & INDUSTRIAL	
Building area:	No. of Parking Spaces:

APPLICANT CERTIFICATION

I hereby request the action contained within this application relative to the property shown on the attached plats and site plan and further request that this item be placed on both the Planning Commission and Board of Commissioners agenda(s) for a public hearing.

I understand that the Planning & Development staff may either accept or reject my request upon review. My request will be rejected if all the necessary data is not presented.

I understand that I have the obligation to present all data necessary and required by statute to enable the Planning Commission and the Board of Commissioners to make an informed determination on my request. I will seek the advice of an attorney if I am not familiar with the zoning and land use requirements.

I understand that my request will be acted upon at the Planning Commission and Board of Commissioner hearings and that I am required to be present or to be represented by someone able to present all facts. I understand that failure to appear at a public hearing may result in the postponement or denial of my rezoning of special use application. I further understand that it is my responsibility to be aware of relevant public hearing dates and times regardless of notification from Dawson County.

I hereby certify that I have read the above and that the above information as well as the attached information is true and correct.

Witness Cariff agsta	Date $10/7/302/$	
WITH Notice: This section only to be completed if applica	IDRAWAL tion is being withdrawn.	
I hereby withdraw application #		
Signature	Date	

Withdrawal of Application:

Withdrawals of any application may be accommodated within the Planning & Development Department if requested before the Planning Commission agenda is set. Therefore, withdrawals may not be made after ten (10) days prior to the scheduled Planning Commission meeting hearing, unless accompanied by written request stating specific reasons for withdrawal. This withdrawal request is to be published in the legal organ prior to the meeting. Following the written request and publication the Planning Commission will vote to remove the item from the agenda at the scheduled hearing. Please note that should the withdrawal be denied, the item will receive deliberation and public hearing with a decision by the Planning Commission. Further, the applicant is encouraged to be present at the hearing to substantiate reasons for withdrawal. Please note that no refund of application fees may be made unless directed by the Board of Commissioners.

ZA	TMP#:
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List of Adjacent Property Owners

It is the responsibility of the Applicant to provide a list of adjacent property owners. This list must include the name and mailing address of anyone who has property touching your property or who has property directly across the street from your property.

**Please note this information should be obtained using the Tax Map & Parcel (TMP) listing for any parcel(s) adjoining or adjacent to the parcel where a variance or rezone is being requested.

		<u>Name</u>	Address
TMP_028 007 002_	1	Clayton Long	57 Bearden Trail, Dawsonville, GA 30534
TMP_049 009 001	2	Susan G Shadix	2498 Venture Drive, Gainesville, GA 30504
TMP 049 199	3	Joel C Crotzer	117 New Hope Trail, Dawsonville, GA 30534
TMP049_198	4	Jennifer Majestic	234 Highway 52 East, Dawsonville, GA 30534
TMP 063 004	5	Michael B Bilbrey	163 Highway 52, Dawsonville, GA 30534
TMP	6		
TMP	7		
TMP	8		
TMP	9		
TMP	10		
TMP	11		
TMP	12		
TMP	13		
TMP	14		
TMP	15		

Use additional sheets if necessary.

Dawson County, Georgia Board of Commissioners

Affidavit for Issuance of a Public Benefit
As Required by the Georgia Illegal Immigration Reform and Enforcement Act of 2011

By executing this affidavit under oath, as an applicant for a Dawson County Business License, Out of County Business Registration, Alcohol License, or other public benefit as referenced in the Georgia Illegal Immigration Reform and Enforcement Act of 2011 [O.C.G.A. § 50-36-1(e)(2)], I am stating the following with respect to my application for such Dawson County public benefit.

X	I am a United States citizen.	
	I am a legal permanent resident of	f the United States. (FOR NON-CITIZENS)
		nigrant under the Federal Immigration and Nationality Act with an alien t of Homeland Security or other federal immigration agency. (FOR NON-
My alien nu	umber issued by the Department of Hom	neland Security or other federal immigration agency is:
secure and		that he or she is 18 years of age or older and has provided at least one y O.C.G.A. § 50-36-1(e)(1), with this affidavit. (See reverse side of this s.)
7	and verifiable document provided with	h this affidavit can best be classified as:
fictitious, o		understand that any person who knowingly and willfully makes a false, on in an affidavit shall be guilty of a violation of O.C.G.A. § 16-10-20 iminal statute.
Executed in Signature of	nAi/A/A/A	(city), $\frac{9/9/2021}{Date}$ (state)
Printed Na		Name of Business
	MY COMM EXPIRES 2/5/2023 PUBLIC	SUBSCRIBED AND SWORN BEFORE ME ON THIS DAY OF Notary Public My Commission Expires: 2-5-23

(Seal)

DAWSON COUNTY VARIANCE APPLICATION

	This portion to be com	pleted by Zonin	g Administrator		
VR Tax Map & Parcel # (TMP):					
Current Zoning:	Comm	Commission District #:			
Submittal Date:	Time:	am/pm	Received by:	(staff initials)	
Fees Assessed:	Paid:				
Planning Commission Mee	ing Date:				
APPLICANT INFOR	MATION (or Authoriz	zed Representa	tive)		
Printed Name:	Greg Spence	_			
Address:					
Phone: Listed Unlisted		Email:	Business Personal		
Status: [] Owner [X] A					
Notice: If applicant is othe	r than owner, enclosed	Property Owne	r Authorization form	must be completed.	
I have X /have not _	participated in a	Pre-application	n meeting with Plannin	ng Staff.	
If not, I agree/dis	agree to schedu	le a meeting th	e week following the	submittal deadline.	
Meeting Date:	Applic	ant Signature: _			
PROPERTY INFORM	<u> MATION</u>				
Street Address of Property:	Parcel ID# 049 00				
Land Lot(s):	District:				
Subdivision/Lot:		Buildir	ng Permit #:	(if applicable)	

Directions to the Property: <u>from 25 Justice Way, travel north on Shoal Creek Rd ~ 5.7 miles, right turn</u>
onto State Rt 342, travel ~3.6 miles, turn right onto GA HWY-52. Site will be in wooded lot ~ 450ft on left
REQUESTED ACTION
A Variance is requested from the requirements of Article #
If other, please describe:
Type of Variance requested:
[] Front Yard [] Side Yard [] Rear Yard variance of feet to allow the structure to:
[X] be constructed; [] remain a distance of feet from the:
[] property line, [] road right of way, or [X] other (explain below): applicant is requesting a variance of approximately 220ft to the tower separation requirement
instead of the required distance of required by the regulations.
[] Lot Size Request for a reduction in the minimum lot size from to
[] Sign Variance for:
[] Home Occupation Variance to operate: business
[] Other (explain request):
If there are other variance requests for this site in past, please list case # and nature of variance:
Variances to standards and requirements of the Regulations, with respect to open area, setbacks, yard area, lot coverage, height, and other quantitative requirements may be granted if, on the basis of the application, investigation, and other evidence submitted by the applicant, all four (4) expressly written findings below are made:
1. Describe why a strict and literal enforcement of the standards would result in a practical difficulty or unnecessary hardship: The proposed tower height is the minimum height needed to properly provide improved coverage and accommodate anticipated future growth for wireless demand in this area. The proposed facility will allow Verizon Wireless to mount cellular antennas at a height of 185 feet above ground level, which is critical to achieve quality coverage and indoor-level service quality in this portion of rural Dawson County. The location of this coverage site will also enable Verizon Wireless to provide calling and

data resources that might be needed in the event of an emergency.
2. Describe the exceptional and extraordinary conditions applicable to this property which do not apply to other properties in the same district: This parcel is located along on the Dawson/Lumpkin County line.
The coverage objective is the intersection of Wesley Chapel Rd and HWY 52. Moving to other parcels to
the West or SW only increases the proximity to the existing tower.
3. Describe why granting a variance would not be detrimental to the public health, safety, morals or welfare and not be materially injurious to properties in the near vicinity:
Approval of this variance will enable Verizon Wireless to provide reliable voice and broadband data coverage
to the surrounding area of northeast Dawson County. The proposed facility will greatly improve wireless and
broadband service coverage to the residents and agribusinesses of the area.
4. Describe why granting this variance would support the general objectives within this Resolution: Verizon Wireless made every attempt to utilize any existing structures to meet the network design goals.
There are no known, registered antenna structures within 1.0 mile of any edge of the search area.
There were also no known or registered antenna structures within 2.0 miles of the search area radius
And for this reason, we believe we meet the general objectives of the Resolution.

Submit clear explanation of all four questions above. You may add sheets if necessary.

(Variances should not be granted if the need arises as a result of action by the applicant or previous owner.)

PROPERTY OWNER AUTHORIZATION

I / we Joyce S. Hutcheson	hereby swear that I / we
own the property located at (fill in address and / or tax map & parcel #):	
Parcel ID# 049-001	
	, , , , , , , , , , , , , , , , , , ,
as shown in the tax maps and / or deed records of Dawson County, Georgia, by this request.	and which parcel will be affected
I hereby authorize the person named below to act as the applicant or agent on this property. I understand that any variance granted, and / or conditional binding upon the property regardless of ownership. The under signer application. The under signer is aware that no application or reapplication acted upon within 6 months from the date of the last action by the Board of 6	ons placed on the property will be below is authorized to make this on affecting the same land shall be
Printed name of applicant or agent: Greg Spence	
Signature of applicant or agent:	Date: 10 7 2021
Printed Name of Owner(s): Joyce S. Hutcheson	
Signature of Owner(s): Joseph S. Hutcheson	Date 9-10-21
Sworn and subscribed before me this 16 day of Suptember, 2021.	
Notary Public	
My Commission Expires: 16 '31'2022	
C. PAIGE BEICHLER Notary Public - State At Large KENTUCKY - Notary ID # 610436 My Comm(\$961) Expires 10/31/2022	

(The complete names of all owners must be listed, if the owner is a partnership, the names of all partners must be listed, if a joint venture, the names of all members must be listed. If a separate sheet is needed to list all names, please identify as applicant or owner and have the additional sheet notarized also.)

ZA		TMP#:
	- ,	

List of Adjacent Property Owners

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TMP_049 009 001_	2 Susan G Shadix	2498 Venture Drive, Gainesville, GA 30504
TMP 049 199	3. Joel C Crotzer	117 New Hope Trail, Dawsonville, GA 30534
TMP 049 198	4. Jennifer Majestic	234 Highway 52 East, Dawsonville, GA 30534
TMP063_004	Michael B Bilbrey 5	163 Highway 52, Dawsonville, GA 30534
TMP	6	
TMP	7	
TMP	8	
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TMP	12	
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TMP	14	
TMP	15	

Use additional sheets if necessary.

APPLICANT CERTIFICATION

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I understand that I have the obligation to present all data necessary and required by statute to enable the Planning Commission and Board of Commissioners to make an informed determination on my request. I will seek the advice of an attorney if I am not familiar with the zoning and land use requirements.

I understand that my request will be acted upon at the Planning Commission and Board of Commissioner hearings and that I am required to be present or to be represented by someone able to present all facts. I understand that failure to appear at a public hearing may result in the postponement or denial of my special use or rezoning application. I further understand that it is my responsibility to be aware of relevant public hearing dates and times regardless of notification from Dawson County.

I hereby certify that I have read the above and that the above information as well as the attached information is true and correct.

Signature of Applicant or Agent:	Date: 10 7 7071
Signature of Witness: Cauff Cong 5 dan	Date: 10/7/3001
***************	************
WITHDRA	AWAL
Notice: This section only to be completed if application is	being withdrawn.
I hereby withdraw application #:	
Signature:	Date:

Withdrawal of Application:

Withdrawals of any application may be accommodated within the Planning & Development office if requested before the Planning Commission agenda is set. Therefore, withdrawals may not be made after ten (10) days prior to the scheduled Planning Commission meeting hearing, unless accompanied by written request stating specific reasons for withdrawal. This withdrawal request is to be published in the legal organ prior to the meeting. Following that written request and publication the Commission will vote to remove the item from the agenda at the scheduled hearing. Please note that should the withdrawal be denied, the item will receive deliberation and public hearing with a decision by the Commission. Further the applicant is encouraged to be present at the hearing to substantiate reasons for withdrawal. Please note that no refund of application fee may be made unless directed by the Board of Commissioners.

Dawson County, Georgia Board of Commissioners

Affidavit for Issuance of a Public Benefit
As Required by the Georgia Illegal Immigration Reform and Enforcement Act of 2011

By executing this affidavit under oath, as an applicant for a Dawson County Business License, Out of County Business Registration, Alcohol License, or other public benefit as referenced in the Georgia Illegal Immigration Reform and Enforcement Act of 2011 [O.C.G.A. § 50-36-1(e)(2)], I am stating the following with respect to my application for such Dawson County public benefit.

X	I am a United States citizen.	
	I am a legal permanent resident of	f the United States. (FOR NON-CITIZENS)
		nigrant under the Federal Immigration and Nationality Act with an alien t of Homeland Security or other federal immigration agency. (FOR NON-
My alien nu	umber issued by the Department of Hom	neland Security or other federal immigration agency is:
secure and		that he or she is 18 years of age or older and has provided at least one y O.C.G.A. § 50-36-1(e)(1), with this affidavit. (See reverse side of this s.)
7	and verifiable document provided with	h this affidavit can best be classified as:
fictitious, o		understand that any person who knowingly and willfully makes a false, on in an affidavit shall be guilty of a violation of O.C.G.A. § 16-10-20 iminal statute.
Executed in Signature of	nAi/A/A/A	(city), $\frac{9/9/2021}{Date}$ (state)
Printed Na		Name of Business
	MY COMM EXPIRES 2/5/2023 PUBLIC	SUBSCRIBED AND SWORN BEFORE ME ON THIS DAY OF Notary Public My Commission Expires: 2-5-23

(Seal)



Filed in Office: 04/07/2014 12:45PM Doc: QCD Bk 01108 Pg 0311-0312 Georgia Transfer Tax Paid: Justin Power Clerk of Court Dawson County 0422014000334

Return to:

John Roger Palmour 583 Riverview Trail East Dahlonega GA 30533

DOC# 000959 FILED IN OFFICE 03/26/2014 09:30 AM BK:1271 PG:482-483 RITA HARKINS CLERK OF COU COURTS LUMPKIN COUNTY

ESTATE TRANSFER TAX PAID: \$0.00 093-2014-000102

QUITCLAIM DEED

STATE OF GEORGIA, COUNTY OF LUMPKIN

THIS INDENTURE, made this day of Mondain the Year of Our Lord Two Thousand Fourteen (2014), between JOHN M. HUTCHESON, of the first part, and JOYCE S. HUTCHESON of the second part,

WITNESSETH: That the said party of the first part, for and in consideration of the Division and the Distribution of Marital Property Pursuant to Final Divorce, has bargained, sold, and by these presents does remise, convey and forever QUIT-CLAIM to the said party of the second part, her heirs, successors and assigns, the following described property:

All that tract or parcel of land lying and being in Land Lots 559, 560, 561, 562, 563, 594, 595, 596, 597, and 598 in the 5th District, 1st Section of Dawson and Lumpkin Counties, Georgia, and being more fully described and delineated according to a plat of survey prepared for Joyce Hutcheson and dated December 27, 2013, by John T. Gaston, Georgia Registered Surveyor, which is recorded in Plat Cabinet One, Slide 198, Plat 143, Lumpkin County Records, and in Plat Book 80, Page 167, Dawson County Records, and which is incorporated by reference herein. This is a portion of the property that was conveyed to John M. Hutcheson, individually, under a Quitclaim Deed from John M. Hutcheson as General Partner of the Gab Creek Farm Family Limited Partnership, LLLP, and which is incorporated by reference herein, said deed having been executed and recorded in order to dissolve and to distribute the assets of said partnership in accordance with the provisions of a document entitled "Unanimous Consent of Members of Gab Creek Farm Family Limited Partnership, LLLP, in Lieu of a Meeting of Members" which is incorporated by reference herein.

Page Two - Quitclaim Deed

This Quitclaim Deed is executed to effectuate the provisions of that certain Final Judgment and Decree of Divorce entered and filed on May 6, 2013, in Lumpkin County Superior Court Civil Action File No. 11-CV-578SG. The said John M. Hutcheson retains full fee simple absolute title to those other portions of the real estate formerly titled in the name of Gab Creek Farm Family Limited Partnership, LLLP, that were conveyed to him under the above referenced Quitclaim Deed, and that are not conveyed to Joyce S. Hutcheson under this deed.


TO HAVE AND TO HOLD the said described premises to the said party of the second part, her heirs, successors and assigns, so that neither the said party of the first part nor his heirs, successors or assigns, nor any other person or persons claiming under him, shall at any time, by any means or ways, have, claim or demand any right or title to the aforesaid described premises or appurtenances, or any rights thereof.

IN WITNESS WHEREOF, the said party of the first part has set his hand and affixed his seal, the day and year above written.

Signed sealed and delivered this day of

tness

Commission Expire

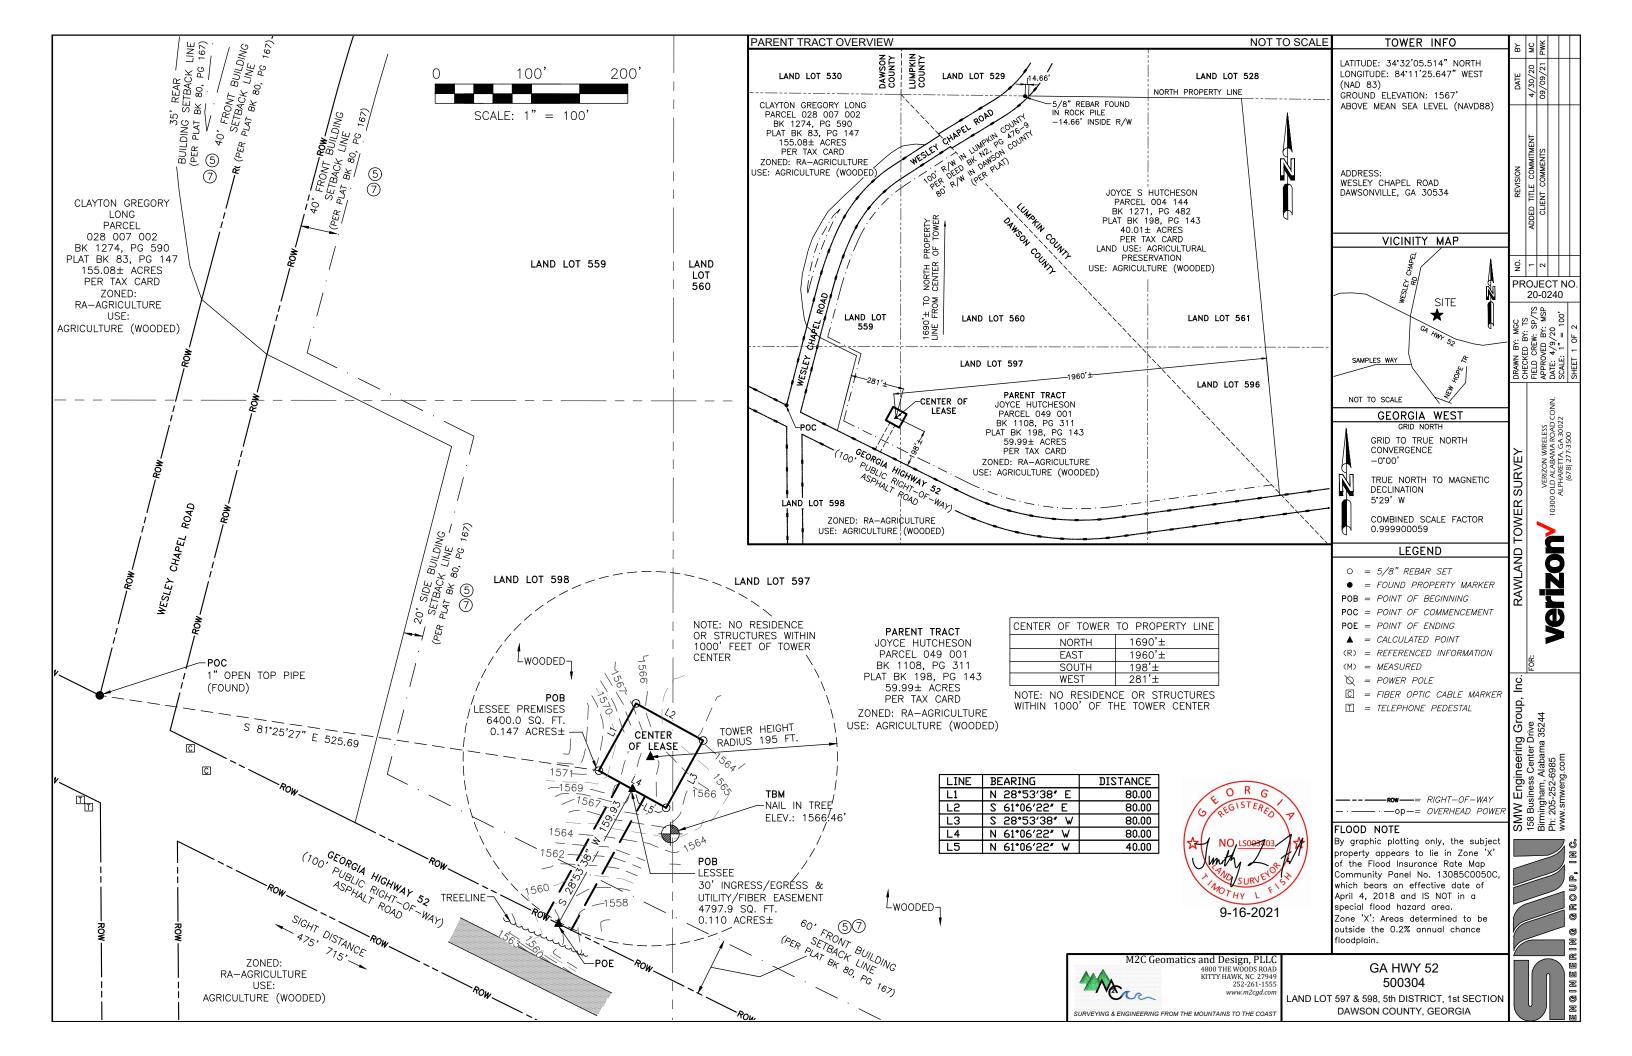

PARENT TRACT (FROM TITLE)

Property located in Dawson & Lumpkin Counties, Georgia

All that tract or parcel of land lying and being in Land Lots 559, 560, 561, 562, 563, 594, 595, 596, 597, and 598 in the 5th District, 1st Section of Dawson and Lumpkin Counties, Georgia, and being more fully described and delineated according to a plat of survey prepared for Joyce Hutcheson and dated December 27, 2013, by John T. Gaston, Georgia Registered Surveyor, which is recorded in Plat Cabinet One, Slide 198, Plat 143, Lumpkin County Records, and in Plat Book 80, Page 167, Dawson County Records, and which is incorporated by reference herein.

AND BEING the same property conveyed to John M. Hutcheson from C. L. Mooney by Warranty Deed dated September 13, 1971 and recorded October 6, 1971 in Deed Book 16, Page 125; FURTHER CONVEYED to John M. Hutcheson and Joyce S. Hutcheson from John M. Hutcheson by Warranty Deed with Rights of Survivorship dated December 7, 2004 and recorded December 16, 2004 in Deed Book 638, Page 92; FURTHER CONVEYED to Gab Creek Farm Family Limited Partnership, LLLP from John M. Hutcheson and Joyce S. Hutcheson by Quitclaim Deed dated September 28, 2006 and recorded March 21, 2007 in Deed Book 799, Page 450; FURTHER CONVEYED to John M. Hutcheson from John M. Hutcheson, in his capacity as General Partner of Gab Creek Farm Family Limited Partnership, LLLP by Quitclaim Deed dated March 26, 2014 and recorded April 7, 2014 in Deed Book 01108, Page 0302; AND FURTHER CONVEYED to Joyce S. Hutcheson from John M. Hutcheson by Quitclaim Deed dated March 26, 2014 and recorded April 7, 2014 in Deed Book 1108, Page 311. Tax Parcel No. 049 001

Lumpkin County:

AND BEING the same property conveyed to John M. Hutcheson from C. L. Mooney by Warranty Deed dated September 13, 1971 and recorded October 6, 1971 in Deed Book Y2, Page 21; FURTHER CONVEYED to John M. Hutcheson and Joyce S. Hutcheson Conveyed December 7, 2004, and recorded December 13, 1971, and 2004, a from John M. Hutcheson by Warranty Deed with Rights of Survivorship dated December 7, 2004 and recorded December 7, 2004 in Deed Book V34, Page 414; FURTHER CONVEYED to Gab Creek Farm Family Limited Partnership, LLLP from John M. Hutcheson and Joyce S. Hutcheson by Quitclaim Deed dated September 28, 2006 and recorded March 26, 2007 in Deed Book 1033, Page and Joyce S. Hutcheson by Quitclaim Deed dated September 28, 2006 and recorded March 26, 2007 in Deed Book 1035, Page 556; FURTHER CONVEYED to John M. Hutcheson from John M. Hutcheson, in his capacity as General Partner of Gab Creek Farm Family Limited Partnership, LLLP by Quitclaim Deed dated March 26, 2014 and recorded March 26, 2014 in Deed Book 1271, Page 473; AND FURTHER CONVEYED to Joyce S. Hutcheson from John M. Hutcheson by Quitclaim Deed dated March 26, 2014 and recorded March 26, 2014 in Deed Book 1271, Page 482. Tax Parcel No. 004 144

80' x 80' LESSEE PREMISES (AS-SURVEYED)

A portion of the Hutcheson tract described in Book 1108, Page 311 as recorded in the Office of the Clerk of the Superior Court of Dawson County, Georgia, lying and being in Land Lots 597, and 598 in the 5th District, 1st Section of Dawson County, Georgia, and being more particularly described as follows;

Commencing at a 1" open top pipe found at the intersection of the northeasterly right—of—way line of Georgia Highway 52 and the westerly right—of—way line of the Wesley Chapel Road and marking the SE Corner of Parcel 028 007 002 as described in Book 1274, Page 590; thence S 81°25'27" E for a distance of 525.69 feet to a 5/8" rebar set and the Point of Beginning: thence N 28'53'38" E for a distance of 80.00 feet to a 5/8" rebar set; thence S 61'06'22" E for a distance of 80.00 feet to a 5/8" rebar set; thence S 28'53'38" W for a distance of 80.00 feet to a 5/8" rebar set; thence N 61°06'22" W for a distance of 80.00 feet to the Point of Beginning. Said Lessee Premises contains (6400.0 sq.ft.) 0.147 acres, more or less.

30' INGRESS/EGRESS & UTILITY/FIBER EASEMENT (AS-SURVEYED)

A portion of the Hutcheson tract described in Book 1108, Page 311 as recorded in the Office of the Clerk of the Superior Court of Dawson County, Georgia, lying and being in Land Lot 598 in the 5th District, 1st Section of Dawson County, Georgia, and being more particularly described as follows;

Commencing at a 1" open top pipe found at the intersection of the northeasterly right-of-way line of Georgia Highway 52 and the westerly right-of-way line of the Wesley Chapel Road and marking the SE Corner of Parcel 028 007 002 as described in Book 1274, Page 590; thence S 81*25*27" E for a distance of 525.69 feet to a 5/8" rebar set; thence N 28'53'38" E for a distance of 80.00 feet to a 5/8" rebar set; thence S 61'06'22" E for a distance of 80.00 feet to a 5/8" rebar set; thence S 28*53'38" W for a distance of 80.00 feet to a 5/8" rebar set; thence N 61*06'22" W for a distance of 40.00 feet and the Point of Beginning of the Lessee Ingress/Egress & Utility Easement being 30 feet in width and lying 15 feet on each side of the following described centerline; thence S 28°53'38" W for a distance of 159.93 feet to a point on the northeasterly right-of-way line of Georgia Highway 52 and the Point of Ending. Said easement contains (4797.9 sa.ft.) 0.110 acres, more or less.

PLOTTABLE EXCEPTIONS

Fidelity National Title Insurance Company Commitment for Title Insurance Commitment No. 30992239 Date March 16, 2020 Schedule B, Section II

Exception No.	<u>Instrument</u>	Comment							
1-2		Standard exceptions. Contain no survey matters.							
3	Plat Book 2, Page 184	Does affect the subject Lease area and easement as shown.							
4	Plat Book 2, Page 280	Does affect the subject Lease area and easement as shown.							
5	Plat Book 80, Page 167	Does affect the subject Lease area and easement as shown hereon.							
6	Plat Book 3, Page 5	Does affect the subject Lease area and easement as shown.							
7	Plat Book 198, Page 143	Does affect the subject Lease area and easement as shown hereon.							
8	Deed Book 1297, Page 125	Agricultural Questionnaire, contains no survey matters.							
9		Standard exception, Contain no survey matters.							

SURVEYOR'S NOTES

- 1. This is a Raw Land Tower Survey, made on the ground under the supervision of a Georgia Registered Land Surveyor. Date of field survey is April 1, 2020.
- 2. The following surveying instruments were used at time of field visit: Topcon DM55 Total Station, Reflectorless and Hiper SR RTK Network Rover with static capability.
- 3. Bearings are based on Georgia West State Plane Coordinates NAD 83 by GPS observation
- 4. No underground utilities, underground encroachments or building foundations were measured or located as a part of this survey, unless otherwise shown. Trees and shrubs not located, unless otherwise shown.
- 5. Benchmark used is a GPS Continuously Operating Reference Station, PID DM7831. Onsite benchmark is as shown hereon. Elevations shown are in feet and refer to NAVD 88.
- 6. This survey was conducted for the purpose of a Raw Land Tower Survey only, and is not intended to delineate the regulatory jurisdiction of any federal, state, regional or local agency, board, commission or other similar entity.
 7. Attention is directed to the fact that this survey may have been reduced or enlarged in size due to reproduction. This
- should be taken into consideration when obtaining scaled data.
- 8. This Survey was conducted with the benefit of an Abstract Title search.
- 9. Surveyor hereby states the Geodetic Coordinates and the elevation shown for the proposed centerline of the tower are accurate to within +/-20 feet horizontally and to within +/-3 feet vertically (FAA Accuracy Code 1A).
- 10. Survey shown hereon conforms to the Minimum Requirements as set forth by the State Board for a Class "A" Survey.
- 11. Field data upon which this map or plat is based has a closure precision of not less than one-foot in 15,000 feet (1':15,000') and an angular error that does not exceed 10 seconds times the square root of the number of angles turned. Field traverse was not adjusted.
- 12. This survey is not valid without the original signature and the original seal of a state licensed surveyor.
- 13. This survey does not constitute a boundary survey of the Parent Tract. Any parent tract property lines shown hereon are from supplied information and may not be field verified.
- 14. Zoning: (as supplied by client) Zoning Jurisdiction: Dawson County Zoning District: RA/Agriculture Surrounding Zoning: N/A

Height Restrictions: 195' Free Standing


SURVEYOR'S CERTIFICATION

I certify that all parts of this survey and drawing have been completed in accordance with the current requirements of the Standards of Practice for Surveying in the State of Georgia to the best of my knowledge, information, and belief,

This plat is a retracement of an existing parcel or parcels of land and does not subdivide or create a new parcel or make any changes to any real property boundaries. The recording information of the documents, maps, plats, or other instruments which created the parcel or parcels are stated hereon. Recordation of this plat does not imply approval of any local jurisdiction, availability of permits, compliance with local regulations or requirements, or suitability for any use or purpose of the land. Furthermore, the undersigned land surveyor certifies that this plat complies with the minimum technical standards for property surveys in Georgia as set forth in the rules and regulations of the Georgia Board of Registration for Professional Engineers and Land Surveyors and as set forth in O.C.G.A. Section 15-6-67

9-16-2021

TIMOTHY L FISH GAPLE # 003403

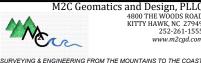

GA HWY 52 500304

LAND LOT 597 & 598, 5th DISTRICT, 1st SECTION DAWSON COUNTY, GEORGIA

- 2


PROJECT NO 20-0240

VERIZON WIRELESS 10300 OLD ALABAMA ROAD CO ALPHARETTA, GA 30022 16781 277-3500

verizon

RAWLAND TOWER SURVEY

/ Engineering Group, II Jainess Center Drive Graftham 35244 5-252-6985 smweng.com

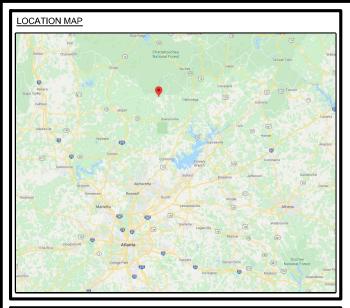



DRIVING DIRECTIONS

DIRECTIONS FROM ATLANTA, GA:
GET ON 1-75 N/1-85 N. FOLLOW SIGNS FOR INTERSTATE 85 N.
USE THE RIGHT 2 LANES TO TAKE EXIT 87 FOR GA-400 N
TOWARD BUCKHEAD/CUMMING. CONTINUE ONTO GA-400 N.
CONTINTUE ONTO GA-400 N/US-19 N. TURN LEFT ONTO MARTIN
RD. TURN RIGHT ONTO GA-9 N. AT THE TRAFFIC CIRCLE, TAKE
THE 1ST EXIT ONTO SHOAL CREEK RD. SLIGHT LEFT ONTO
GA-136 W. TURN RIGHT ONTO STATE RTE 342. TURN RIGHT
ONTO GA-52 E AND YOUR DESTINATION WILL BE ON THE LEFT.

DEPARTMENT	NAME/SIGNATURE	DATE
LAND/TOWER OWNER		
SITE ACQU. AGENT		
ZONING/PERMITING AGENT		
A&E MANAGER		
CONSTRUCTION MANAGER		
RF MANAGER		

'ERIZON SITE NAME:

GA_HWY52

VERIZON SITE #:

500304

PROJECT DESCRIPTION:

RAWLAND NSB
PROPOSED 190' MONOPOLE
TOTAL TOWER HEIGHT INCLUDING THE APPURTENANCE - 195' AGL

PREPARED FOR:



10300 OLD ALABAMA ROAD CONN. ALPHARETTA, GA 30022 (678) 277-3500

PREPARED BY:



TOGETHER PLANNING A BETTER TOMORROW

158 BUSINESS CENTER DRIVE BIRMINGHAM, AL 35244 TEL: 205-252-6985 FAX: 205-320-1504 PROJECT INFORMATION

SITE ADDRESS: NEAR WESLEY CHAPEL RD

DAWSONVILLE, GA 30534

LATITUDE (NAD 83): N 34° 32' 05.514" LONGITUDE (NAD 83): W 84° 11' 25.647"

LATITUDE (NAD DECIMAL): N 34.534865° LONGITUDE (NAD DECIMAL): W 84.190458°

PARCEL ID: 049 001

JURISDICTION: DAWSON COUNTY
PROPERTY OWNER: JOYCE HUTCHESON

APPLICANT: VERIZON WIRELESS

10300 OLD ALABAMA ROAD CONN ALPHARETTA, GA 30022

ENGINEER: SMW ENGINEERING

158 BUSINESS CENTER DRIVE BIRMINGHAM, AL 35244 CONTACT: JEREMY SHARIT, PE PHONE: 205-397-6781

POWER: AMICALOLA EMC

FIBER: FIBER COMPANY AWARDED BY VERIZON

AT FUTURE TIME, CONSULT CM

DRAWING INDEX

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-- SURVEY

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C-2 OVERALL PARENT TRACT

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C-2.2 OVERALL SITE PLAN OVERLAY

C-3 DETAILED SITE PLAN

C-4 DETAILED EQUIPMENT PLAN & DETAILS

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E-5 GROUNDING DETAILS
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ENGINEERING GROUP, INC.



0 04/21/20 ISSUED FOR CLIENT REV.	1 04/28/20 ISSUED FOR CLIENT REV.	2 05/12/20 ISSUED FOR CONSTRUCTION	3 06/12/20 ISSUED FOR CONSTRUCTION	4 07/21/20 ISSUED FOR CONSTRUCTION	5 09/09/21 ISSUED FOR CONSTRUCTION	6 09/13/21 REVISED PER CLIENT COMMENT		
04/21/20 ISS	04/28/20 ISS	05/12/20 ISS	06/12/20 ISS	02/12/20	9/09/21 ISS	09/13/21 RE		
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SITE NAME
GA HWY52

SMW#: 20-0240

FUZE ID: 16093185 PSLC #: 500304

DESIGNED: JDS
DRAWN: MEH
CHECKED: BS


SHEET NAME

TITLE SHEET & PROJECT INFORMATION

SHEET NUMBER

T-1



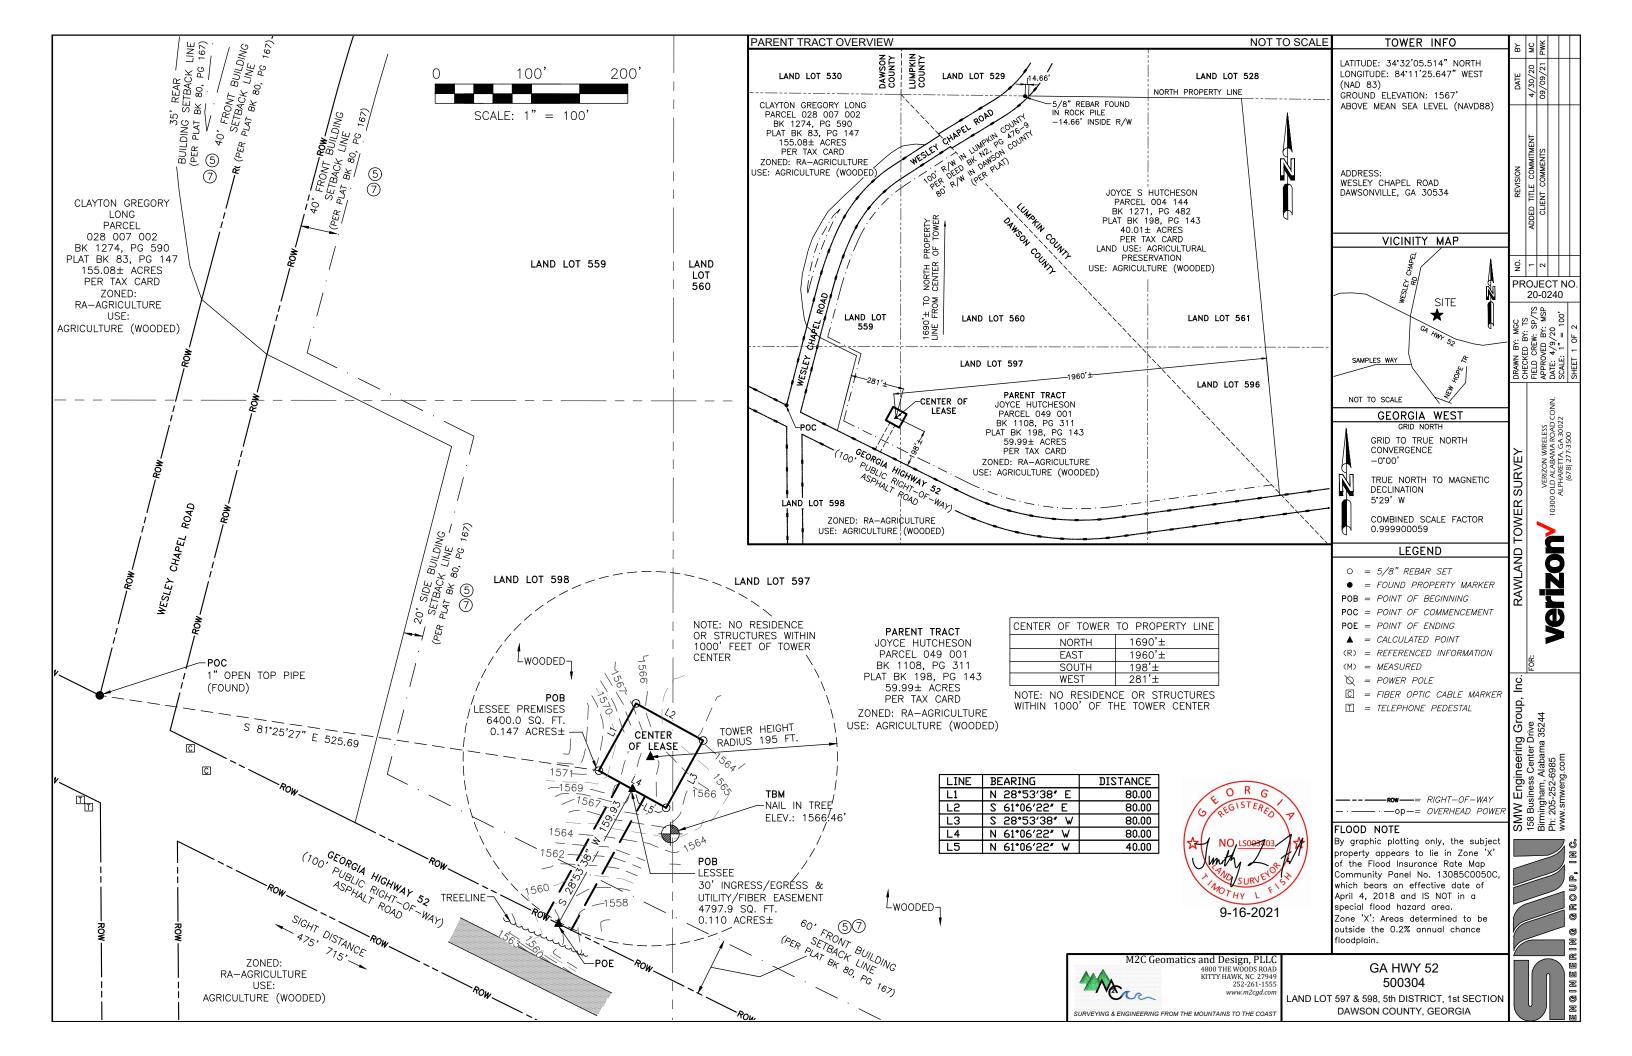

PARENT TRACT (FROM TITLE)

Property located in Dawson & Lumpkin Counties, Georgia

All that tract or parcel of land lying and being in Land Lots 559, 560, 561, 562, 563, 594, 595, 596, 597, and 598 in the 5th District, 1st Section of Dawson and Lumpkin Counties, Georgia, and being more fully described and delineated according to a plat of survey prepared for Joyce Hutcheson and dated December 27, 2013, by John T. Gaston, Georgia Registered Surveyor, which is recorded in Plat Cabinet One, Slide 198, Plat 143, Lumpkin County Records, and in Plat Book 80, Page 167, Dawson County Records, and which is incorporated by reference herein.

AND BEING the same property conveyed to John M. Hutcheson from C. L. Mooney by Warranty Deed dated September 13, 1971 and recorded October 6, 1971 in Deed Book 16, Page 125; FURTHER CONVEYED to John M. Hutcheson and Joyce S. Hutcheson from John M. Hutcheson by Warranty Deed with Rights of Survivorship dated December 7, 2004 and recorded December 16, 2004 in Deed Book 638, Page 92; FURTHER CONVEYED to Gab Creek Farm Family Limited Partnership, LLLP from John M. Hutcheson and Joyce S. Hutcheson by Quitclaim Deed dated September 28, 2006 and recorded March 21, 2007 in Deed Book 799, Page 450; FURTHER CONVEYED to John M. Hutcheson from John M. Hutcheson, in his capacity as General Partner of Gab Creek Farm Family Limited Partnership, LLLP by Quitclaim Deed dated March 26, 2014 and recorded April 7, 2014 in Deed Book 01108, Page 0302; AND FURTHER CONVEYED to Joyce S. Hutcheson from John M. Hutcheson by Quitclaim Deed dated March 26, 2014 and recorded April 7, 2014 in Deed Book 1108, Page 311. Tax Parcel No. 049 001

Lumpkin County:

AND BEING the same property conveyed to John M. Hutcheson from C. L. Mooney by Warranty Deed dated September 13, 1971 and recorded October 6, 1971 in Deed Book Y2, Page 21; FURTHER CONVEYED to John M. Hutcheson and Joyce S. Hutcheson Conveyed December 7, 2004, and recorded December 13, 1971, and 2004, a from John M. Hutcheson by Warranty Deed with Rights of Survivorship dated December 7, 2004 and recorded December 7, 2004 in Deed Book V34, Page 414; FURTHER CONVEYED to Gab Creek Farm Family Limited Partnership, LLLP from John M. Hutcheson and Joyce S. Hutcheson by Quitclaim Deed dated September 28, 2006 and recorded March 26, 2007 in Deed Book 1033, Page and Joyce S. Hutcheson by Quitclaim Deed dated September 28, 2006 and recorded March 26, 2007 in Deed Book 1035, Page 556; FURTHER CONVEYED to John M. Hutcheson from John M. Hutcheson, in his capacity as General Partner of Gab Creek Farm Family Limited Partnership, LLLP by Quitclaim Deed dated March 26, 2014 and recorded March 26, 2014 in Deed Book 1271, Page 473; AND FURTHER CONVEYED to Joyce S. Hutcheson from John M. Hutcheson by Quitclaim Deed dated March 26, 2014 and recorded March 26, 2014 in Deed Book 1271, Page 482. Tax Parcel No. 004 144

80' x 80' LESSEE PREMISES (AS-SURVEYED)

A portion of the Hutcheson tract described in Book 1108, Page 311 as recorded in the Office of the Clerk of the Superior Court of Dawson County, Georgia, lying and being in Land Lots 597, and 598 in the 5th District, 1st Section of Dawson County, Georgia, and being more particularly described as follows;

Commencing at a 1" open top pipe found at the intersection of the northeasterly right—of—way line of Georgia Highway 52 and the westerly right—of—way line of the Wesley Chapel Road and marking the SE Corner of Parcel 028 007 002 as described in Book 1274, Page 590; thence S 81°25'27" E for a distance of 525.69 feet to a 5/8" rebar set and the Point of Beginning: thence N 28'53'38" E for a distance of 80.00 feet to a 5/8" rebar set; thence S 61'06'22" E for a distance of 80.00 feet to a 5/8" rebar set; thence S 28'53'38" W for a distance of 80.00 feet to a 5/8" rebar set; thence N 61°06'22" W for a distance of 80.00 feet to the Point of Beginning. Said Lessee Premises contains (6400.0 sq.ft.) 0.147 acres, more or less.

30' INGRESS/EGRESS & UTILITY/FIBER EASEMENT (AS-SURVEYED)

A portion of the Hutcheson tract described in Book 1108, Page 311 as recorded in the Office of the Clerk of the Superior Court of Dawson County, Georgia, lying and being in Land Lot 598 in the 5th District, 1st Section of Dawson County, Georgia, and being more particularly described as follows;

Commencing at a 1" open top pipe found at the intersection of the northeasterly right-of-way line of Georgia Highway 52 and the westerly right-of-way line of the Wesley Chapel Road and marking the SE Corner of Parcel 028 007 002 as described in Book 1274, Page 590; thence S 81*25*27" E for a distance of 525.69 feet to a 5/8" rebar set; thence N 28'53'38" E for a distance of 80.00 feet to a 5/8" rebar set; thence S 61'06'22" E for a distance of 80.00 feet to a 5/8" rebar set; thence S 28*53'38" W for a distance of 80.00 feet to a 5/8" rebar set; thence N 61*06'22" W for a distance of 40.00 feet and the Point of Beginning of the Lessee Ingress/Egress & Utility Easement being 30 feet in width and lying 15 feet on each side of the following described centerline; thence S 28°53'38" W for a distance of 159.93 feet to a point on the northeasterly right-of-way line of Georgia Highway 52 and the Point of Ending. Said easement contains (4797.9 sa.ft.) 0.110 acres, more or less.

PLOTTABLE EXCEPTIONS

Fidelity National Title Insurance Company Commitment for Title Insurance Commitment No. 30992239 Date March 16, 2020 Schedule B, Section II

Exception No.	<u>Instrument</u>	Comment							
1-2		Standard exceptions. Contain no survey matters.							
3	Plat Book 2, Page 184	Does affect the subject Lease area and easement as shown.							
4	Plat Book 2, Page 280	Does affect the subject Lease area and easement as shown.							
5	Plat Book 80, Page 167	Does affect the subject Lease area and easement as shown hereon.							
6	Plat Book 3, Page 5	Does affect the subject Lease area and easement as shown.							
7	Plat Book 198, Page 143	Does affect the subject Lease area and easement as shown hereon.							
8	Deed Book 1297, Page 125	Agricultural Questionnaire, contains no survey matters.							
9		Standard exception, Contain no survey matters.							

SURVEYOR'S NOTES

- 1. This is a Raw Land Tower Survey, made on the ground under the supervision of a Georgia Registered Land Surveyor. Date of field survey is April 1, 2020.
- 2. The following surveying instruments were used at time of field visit: Topcon DM55 Total Station, Reflectorless and Hiper SR RTK Network Rover with static capability.
- 3. Bearings are based on Georgia West State Plane Coordinates NAD 83 by GPS observation
- 4. No underground utilities, underground encroachments or building foundations were measured or located as a part of this survey, unless otherwise shown. Trees and shrubs not located, unless otherwise shown.
- 5. Benchmark used is a GPS Continuously Operating Reference Station, PID DM7831. Onsite benchmark is as shown hereon. Elevations shown are in feet and refer to NAVD 88.
- 6. This survey was conducted for the purpose of a Raw Land Tower Survey only, and is not intended to delineate the regulatory jurisdiction of any federal, state, regional or local agency, board, commission or other similar entity.
 7. Attention is directed to the fact that this survey may have been reduced or enlarged in size due to reproduction. This
- should be taken into consideration when obtaining scaled data.
- 8. This Survey was conducted with the benefit of an Abstract Title search.
- 9. Surveyor hereby states the Geodetic Coordinates and the elevation shown for the proposed centerline of the tower are accurate to within +/-20 feet horizontally and to within +/-3 feet vertically (FAA Accuracy Code 1A).
- 10. Survey shown hereon conforms to the Minimum Requirements as set forth by the State Board for a Class "A" Survey.
- 11. Field data upon which this map or plat is based has a closure precision of not less than one-foot in 15,000 feet (1':15,000') and an angular error that does not exceed 10 seconds times the square root of the number of angles turned. Field traverse was not adjusted.
- 12. This survey is not valid without the original signature and the original seal of a state licensed surveyor.
- 13. This survey does not constitute a boundary survey of the Parent Tract. Any parent tract property lines shown hereon are from supplied information and may not be field verified.
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Height Restrictions: 195' Free Standing


SURVEYOR'S CERTIFICATION

I certify that all parts of this survey and drawing have been completed in accordance with the current requirements of the Standards of Practice for Surveying in the State of Georgia to the best of my knowledge, information, and belief,

This plat is a retracement of an existing parcel or parcels of land and does not subdivide or create a new parcel or make any changes to any real property boundaries. The recording information of the documents, maps, plats, or other instruments which created the parcel or parcels are stated hereon. Recordation of this plat does not imply approval of any local jurisdiction, availability of permits, compliance with local regulations or requirements, or suitability for any use or purpose of the land. Furthermore, the undersigned land surveyor certifies that this plat complies with the minimum technical standards for property surveys in Georgia as set forth in the rules and regulations of the Georgia Board of Registration for Professional Engineers and Land Surveyors and as set forth in O.C.G.A. Section 15-6-67

9-16-2021

TIMOTHY L FISH GAPLE # 003403

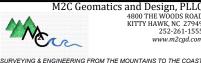

GA HWY 52 500304

LAND LOT 597 & 598, 5th DISTRICT, 1st SECTION DAWSON COUNTY, GEORGIA

- 2

PROJECT NO 20-0240

VERIZON WIRELESS 10300 OLD ALABAMA ROAD CO ALPHARETTA, GA 30022 16781 277-3500

verizon

RAWLAND TOWER SURVEY

/ Engineering Group, II Jainess Center Drive Graftham 35244 5-252-6985 smweng.com

GENERAL NOTES:

- ALL CONSTRUCTION TO COMPLY WITH THE FOLLOWING CODES PLUS LATEST STATE AMENDMENTS:
- INTERNATIONAL BUILDING CODE 2009 EDITION NFPA NATIONAL ELECTRICAL CODE 2011 EDITION INTERNATIONAL MECHANICAL CODE 2009 EDITION INTERNATIONAL FULL GAS CODE 2009 EDITION INTERNATIONAL PLUMBING CODE 2009

- INTERNATIONAL RESIDENTIAL CODE FOR ONE & TWO FAMILY DWELLINGS 2009 EDITION INTERNATIONAL EXISTING BUILDING CODE 2009 EDITION MASONRY CODE ASCE 5—10
- STRUCTURAL CONCRETE CODE ACL 318-11
- STRUCTURAL CONCRETE CODE ACI 310-11
 INTERNATIONAL ENERGY CONSERVATION CODE 2009 EDITION
 ON THE DRAWII
 STRUCTURAL STANDARDS FOR STEEL ANTENNA TOWERS AND ANTENNA SUPPORTING STRUCTURES (TIA/EIA-222-CONNECTIONS:
 5.1. ALL WELDIN
- 2. CONTRACTOR IS TO COMPLY WITH THE REQUEST FOR QUOTATION (RFQ) AND CONSTRUCTION SPECIFICATIONS (LATEST REVISION) & BUILDING MANUFACTURER'S DRAWINGS, ALL PREVIOUSLY PROVIDED BY VERIZON WIRELESS.

 DIMENSIONS TO ALL EXISTING SITE FEATURES SHALL BE FIELD VERIFIED BY THE CONTRACTOR & ANY
- DISCREPANCIES SHALL BE REPORTED TO THE OWNER'S REPRESENTATIVE.
 THE CONTRACTOR SHALL DETERMINE THE EXACT LOCATION OF EXISTING UTILITIES, PIPES, OR ANY
 OTHER SUBSURFACE STRUCTURES PRIOR TO COMMENCING WORK. THE CONTRACTOR SHALL CONTACT
 THE LOCAL UTILITY LOCATING SERVICE 48 HRS PRIOR TO DIGGING, DRILLING, OR BLASTING.
- VERIZON'S CONSTRUCTION PROJECT MANAGER OR VERIZON'S REPRESENTATIVE SHALL BE NOTIFIED IN WRITING OF ANY CONDITIONS THAT VARY FROM THE PLANS. THE CONTRACTOR'S WORK SHALL NOT VARY FROM THE PLANS WITHOUT THE EXPRESSED WRITTEN APPROVAL OF VERIZON'S CONSTRUCTION PROJECT MANAGER OR VERIZON'S REPRESENTATIVE.
- IT SHALL BE THE CONTRACTOR'S RESPONSIBILITY TO EXAMINE ALL DRAWINGS & SPECIFICATIONS AND TO COORDINATE HIS WORK WITH THE WORK OF ALL OTHERS TO ENSURE THAT WORK PROGRESSION IS
- CONTRACTOR SHALL COORDINATE THE CONSTRUCTION SCHEDULE WITH THE PROPERTY OWNER AS TO
- AVOID ANY INTERRUPTIONS WITH THE PROPERTY OWNER'S OPERATIONS.
 CONTRACTOR SHALL KEEP THE PROJECT SITE FREE FROM ACCUMULATION OF WASTE MATERIALS &
 RUBBISH AT ALL TIMES DURING THE CONSTRUCTION PERIOD, & SHALL REMOVE ALL WASTE MATERIALS
 & RUBBISH FROM THE PROJECT SITE AT THE COMPLETION OF WORK, EXCEPT THOSE SPECIFICALLY
 REQUIRED BY THE CONTRACT DOCUMENTS TO BE LEFT FOR THE OWNER'S MAINTENANCE.
- 9. THE CONTRACTOR SHALL RESTORE ALL PROPERTY TO IT'S PRE-CONSTRUCTION CONDITION TO THE
- OWNER'S SATISFACTION.

 10. THE CONTRACTOR SHALL PROTECT EXISTING PROPERTY LINE MONUMENTATION. ANY DISTURBED, DAMAGED, OR REMOVAL OF MONUMENTATION SHALL BE REPLACED AT THE CONTRACTOR'S EXPENSE UNDER THE SUPERVISION OF A REGISTERED LAND SURVEYOR.
- 11. DAMAGE TO EXISTING STRUCTURES & UTILITIES SHALL BE REPAIRED OR REPLACED TO OWNER'S SATISFACTION AT THE CONTRACTOR'S EXPENSE, MAINTAIN FLOW FOR ALL UTILITIES.

 12. ALL UTILITY CONNECTIONS TO EXISTING SYSTEMS SHALL BE COORDINATED WITH THE OWNER OR
- OWNER'S REPRESENTATIVE AND THE UTILITY COMPANY PRIOR TO EACH CONNECTION.


 13. UNLESS OTHERWISE INDICATED, VERIZON SHALL OBTAIN & PROVIDE CONSTRUCTION PERMITS. THE CONTRACTOR SHALL OBTAIN, AT HIS OWN EXPENSE, ALL REQUIRED LOCAL, CITY, STATE AND/OR COUNTY CONSTRUCTION LICENSES. UPON COMPLETION OF THE WORK, THE CONTRACTOR SHALL APPLY FOR & PROVIDE A CERTIFICATE OF OCCUPANCY.
- 14. THE CONTRACTOR SHALL BE RESPONSIBLE FOR DEWATERING AND THE MAINTENANCE OF SURFACE FOR
- 15. CONTRACTOR SHALL COMPLY WITH ALL LOCAL, STATE, & FEDERAL REGULATIONS.

 16. CONSTRUCTION WASTE MAY NEITHER BE BURNED NOR BURIED AND MUST BE TAKEN TO AN APPROVED LANDFILL
- LANDFILL.

 17. SECURITY TO THE SITE SHALL BE MAINTAINED AT ALL TIMES.

 18. CONTRACTOR IS RESPONSIBLE FOR THE CONDITION OF THE SHELTER DURING AND AFTER CONSTRUCTION. THE EQUIPMENT SHELTER SHALL NOT BE USED FOR STORAGE OF TOOLS, CONSTRUCTION MATERIALS OR EQUIPMENT. CONTRACTOR SHALL ENSURE THE SHELTER IS CLEANED AT CONCLUSION OF CONSTRUCTION AND THE FLOOR CLEANED, WAXED, AND BUFFED TO SHINE.
- 19. FOR GREENFIELD/NEW TOWERS SITES, CONTRACTOR IS RESPONSIBLE FOR ENSURING THE TOWER LIGHTS ARE MONITORED MORNING AND NIGHT EACH 24 HRS FROM THE TIME THE TOWER IS TOPPED OUT UNTIL SITE HAS ALARMS CONNECTED TO THE OPERATIONS SWITCH OR NOC. CONTRACTOR TO NOTIFY PROJECT MANAGER AT THE TIME THE TOWER IS TOPPED OUT TO FOWARD NOTIFICATION TO VERIZON REGULATORY AND FCC/FAA.

LEGEND

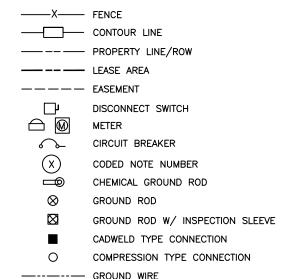

STRUCTURAL STEEL NOTES:

- 1. STRUCTURAL STEEL SHALL CONFORM TO THE LATEST EDITION OF THE AISC "SPECIFICATION FOR THE
- DESIGN, FABRICATION & ERECTION OF STRUCTURAL STEEL FOR BUILDINGS".

 2. ALL INTERIOR STRUCTURAL STEEL SHALL BE FINISHED WITH ONE COAT FABRICATOR'S NON-LEAD, RED OXIDE PRIMER. PRIMING SHALL BE PERFORMED AFTER SHOP FABRICATION TO THE GREATEST EXTENT
- OXIDE PRIMER. PRIMING SHALL BE PERFORMED AFTER SHOP FABRICATION TO THE GREATEST EXTENT POSSIBLE. ALL DINGS, SCRAPES, MARS, & WELDS IN THE PRIMED AREAS SHALL BE REPAIRED BY FIELD TOUCH—UP PRIOR TO COMPLETION OF THE WORK.

 ALL STREICTURAL STEEL SHALL BE GALVANIZED IN ACCORDANCE WITH THE SPECIFICATION ASTM A123 UNLESS OTHERWISE NOTED. GALVANIZING SHALL BE PERFORMED AFTER SHOP FABRICATION TO THE GREATEST EXTENT POSSIBLE. ALL DINGS, SCRAPES, MARS, & WELDS SHALL BE REPAIRED BY FIELD TOUCH—UP PRIOR TO COMPLETION OF THE WORK.

 4. HOLES SHALL NOT BE PLACED THROUGH STRUCTURAL STEEL MEMBERS EXCEPT AS SHOWN AND DETAILED ON THE DRAWNINGS.
- ON THE DRAWINGS.
- ALL WELDING SHALL BE DONE USING E70XX ELECTRODES AND SHALL CONFORM TO AISC AND AWS D1.1. WHERE FILLET WELD SIZES ARE NOT SHOWN, PROVIDE THE MINIMUM SIZE PER TABLE J2.4 IN THE AISC "MANUAL OF STEEL CONSTRUCTION", 13TH EDITION. AT THE COMPLETION OF WELDING, ALL DAMAGE TO GALVANIZED COATING SHALL BE REPAIRED.
- BOLTED CONNECTIONS SHALL USE BEARING TYPE GALVANIZED ASTM A325 BOLTS (3/4") AND SHALL HAVE A MINIMUM OF TWO BOLTS UNLESS NOTED OTHERWISE.

 NON-STRUCTURAL CONNECTIONS FOR STEEL GRATING MAY USE 5/8" DIA GALVANIZED ASTM A307
- BOLTS UNLESS NOTED OTHERWISE.
 CONNECTION DESIGN BY FARRICATE
- NNECTION DESIGN BY FABRICATOR WILL BE SUBJECT TO REVIEW AND APPROVAL BY ENGINEER.
- 6. STEEL SHAPE: 6.1. W SHAPES ASTM A992, GR 50, A 36 6.2. PLATES, ANGLES, CHANNELS ASTM A36 6.3. PIPES A53 GR B

AWNING NOTES:

- 1. DESIGN GRAVITY LOADS:
- ROOF LIVE LOAD = 20 PSF 2. DESIGN WIND LOADS:
- RISK CATEGORY I
- BASIC WIND SPEED = 105 MPH

- ANTENNA NOTES:

 1. AFTER ANTENNA INSTALLATION, LABEL EACH COAXIAL CABLE LINE WITH STRIPS OF COLORED, UV RESISTANT TAPE AT BOTH ENDS OF EVERY LINE. IDENTIFICATION TAPE AS SHOWN ON TOWER ELEVATION PAGE.

 2. TEST ALL COMPONENTS UPON COMPLETION OF INSTALLATION TO ENSURE THAT ALL ITEMS HAVE BEEN PROPERLY INSTALLED AND ARE OPERATIONAL AS INTENDED.

- PROPERLY INSTALLED AND ARE OPERATIONAL AS INTENDED.

 3. TEST CRITERIA;

 3.1. ALL CABLES SHALL BE TESTED BETWEEN 700-1900 MHZ.

 3.2. ALL ANTENNAS MUST MEET A RETURN LOSS OF 16DB OR BETTER.

 3.3. ALL INSERTION LOSS SHALL MEET OR BE LESS THAN THAT SPECIFIED ON THE EBTS WORKSHEET.

 4. EQUIPMENT REQUIRED MINIMUM TEST EQUIPMENT SHALL INCLUDE:

 4.1. SWEPT-FREQUENCY SCALAR NETWORK ANALYZER SYSTEM.

 4.2. SIGNAL SEPARATION DEVICE WITH A DIRECTIVITY OF AT LEAST 40DB BETTER THAN THE HIGHEST RETURN LOSS IT IS REQUIRED TO MEASURE.

 4.3. PRINTER OR PLOTTER CABLE CAPABLE OF PRODUCING 8.5"X11" COPIES (DIGITAL PRINTERS LINACCEPTABLE) FOR RECORDING PERMANENT RECORD OF MEASURED RETURN LOSS & INSERTION UNACCEPTABLE) FOR RECORDING PERMANENT RECORD OF MEASURED RETURN LOSS & INSERTION LOSS AND INSERTION CHARACTERISTICS. A TIME DOMAIN REFLECTOMETER (TDR) FOR FAULT LOCATION
- 5. TESTS REQUIRED: CABLE RETURN LOSS (INCLUDES TOP & BOTTOM JUMPERS).
- LOAD TEST; SHOULD BE -400B OR BETTER.

 CABLE INSERTION LOSS MUST MEET OR BE LESS THAN THE MANUFACTURER'S PUBLISHED SPECIFICATIONS.
- 5.4. SYSTEM RETURN LOSS IF SYSTEM SWEEPS BETTER THAN LOAD, THERE IS A PROBLEM IN THE SYSTEM.

 6. TEST DOCUMENTATION:
- THE FOLLOWING DATA MUST BE INCLUDED FOR EACH ANTENNA TESTED:
- INSERTION LOSS DATA.

 RETURN LOSS INTO 500HM LOAD, SWEEP MEASUREMENTS.

 RETURN LOSS INTO ANTENNA SWEEP MEASUREMENTS.
- DOCUMENTATION FORMAT
- 6.2.2.
- COPIES OF ALL TEST DATA MUST BE PLACED IN BINDERS.
 PROVIDE TWO (2) COPIES OF ALL TEST DATA, ONE COPY TO REMAIN AT SITE & ONE COPY FOR THE VERIZON PROJECT MANAGER.
- ALL TESTS MUST BE LOGGED AND DATED.

 SWEEP MEASUREMENTS MUST BE CHART RECORDED & DATED.

THE ADJACENT TABLE IS THE MINIMUM THAT OPERATIONS IS REQUIRED TO PROVIDE DURING A COMPLETE SYSTEM RETURN LOSS TEST (I.E. WITH IN-LINE DUPLEXERS, DIPLEXERS, SURGE ARRESTORS, ETC.) THE VALUES WITHIN THIS TABLE ARE CONSIDERED PASS VALUES FOR A NEW OR EXISTING SYSTEM, GENERAL CONTRACTOR- BASED ON THESE TABLES, GC IS REQUIRED TO PROVIDE A SYSTEM SWEEP FROM THE CONNECTOR AT THE HATCH PLATE WITH A READING OF -20DB OR BETTER, TO ALLOW OPERATIONS TO GET THEIR REQUIRED READINGS.

FOR DTF TESTING WITH LOAD TERMINATION ON NEW OR EXISTING COAX/CONNECTORS: PASS CRITERIA FOR MAIN FEED LINE (MFL) OR ANY JUMPER -40 DB OR BETTER PASS CRITERIA FOR DIN AND MFL CONNECTORS -30 DB OR BETTER PASS CRITERIA FOR N CONNECTORS -27.5 DB OR BETTER

CONCRETE NOTES:

- DESIGN & CONSTRUCTION OF ALL CONCRETE ELEMENTS SHALL CONFORM TO THE LATEST EDITION OF THE FOLLOWING APPLICABLE CODES: ACI 301 "SPECIFICATIONS FOR STRUCTURAL CONCRETE FOR BUILDINGS"; ACI 318 "BUILDING CODE REQUIREMENTS FOR REINFORCED CONCRETE".
- MIX DESIGN SHALL BE APPROVED BY OWNER'S REPRESENTATIVE PRIOR TO PLACING CONCRETE.
- CONCRETE SHALL BE NORMAL WEIGHT, 6% AIR ENTRAINED (±1.5%) WITH A MAXIMUM 4" SLUMP AND A MINIMUM 28-DAY COMPRESSIVE STRENGTH OF 3000 PSI UNLESS NOTED OTHERWISE.
- CONCRETE MATERIALS: ASTM C 150, TYPE I
- PORTLAND CEMENT
 REINFORCEMENT
 NORMAL WEIGHT AGGREGATE ASTM A 185 ATSM C 33
- WATER POTABLE
- ADMIXTURES
 ADMIXTURES
 NON-CHLORIDE

 5. REINFORCING DETAILS SHALL BE IN ACCORDANCE WITH THE LATEST EDITION OF ACI 315.

 6. REINFORCING STEEL SHALL CONFORM TO ASTM A615, GRADE 60, DEFORMED, UNLESS NOTED OTHERWISE. WWF SHALL CONFORM TO ASTM A185 UNLESS NOTED OTHERWISE. SPLICES SHALL BE CLASS "B" AND HOOKS SHALL BE ASTM STANDARD UNLESS NOTED OTHERWISE.
 MINIMUM COVER FOR REINFORCING STEEL:
- CONCRETE CAST AGAINST EARTH
- EXPOSED CONCRETE #6 & LARGER - 2 IN, #5 & SMALLER - 1 1/2 IN
- NON-EXPOSED SLAB & WALL NON-EXPOSED BEAMS & COLUMNS 3/4 IN NON-CHLORIDE
- 8. A 3/4" CHAMFER SHALL BE PROVIDED AT ALL EXPOSED EDGES OF CONCRETE IN ACCORDANCE WITH ACI 301,
- 9. INSTALLATION OF CONCRETE EXPANSION/WEDGE ANCHOR SHALL BE PER MANUFACTURER'S RECOMMENDATIONS. NO
- REINFORCING SHALL BE CUT WITHOUT ENCINEER'S APPROVAL.

 10. CURING COMPOUNDS SHALL CONFORM TO ASTM C 309.

 11. ADMIXTURES SHALL CONFORM TO THE APPROPRIATE ASTM STANDARD AS REFERENCED IN ACI 301.

- 11. ADMIXTURES SHALL CONFORM TO THE APPROPRIATE ASTANDARD AS REFERENCED IN ACT 301.

 12. DO NOT WELD OR TACK WELD REINFORCING STEEL.

 13. ALL PENETRATIONS SHALL BE IN PLACE PRIOR TO CONCRETE PLACEMENT.

 14. REINFORCEMENT SHALL BE COLD BENT WHENEVER BENDING IS REQUIRED.

 15. CONCRETE SHALL NOT BE PLACED IN WATER, ICE, OR ON FROZEN GROUND.

 16. DO NOT ALLOW CONCRETE SUBBASE TO FREEZE DURING CONCRETE CURING AND SETTING PERIOD.

 17. FOR COLD WEATHER & HOT WEATHER PLACEMENT, CONFORM TO APPLICABLE ACI CODES AND RECOMMENDATIONS.

- GENERATOR, DIESEL & LPG TANK NOTES:

 1. INSTALLATION OF ALL GENERATORS AND DIESEL/LPG TANK INSIDE OR OUTSIDE MUST MEET ALL APPLICABLE NFPA
- 2. ALL FUEL PIPING CONNECTION INSTALLED AT THE SITE MUST BE PRESSURE TESTED PER LOCAL CODE REQUIREMENTS BEFORE STARTING OF GENERATOR. IN FLOOD ZONES LPG TANK FOUNDATION MUST BE INCREASED FROM A DEPTH OF 4" TO 20" TO PREVENT TANK FROM FLOATING AWAY IN A FLOOD.





SITE NAME GA HWY52

SMW#: 20-0240 FUZE ID: 16093185

DESIGNED: JDS DRAWN: MFH CHECKED: BS

PSLC #: 500304

SHFFT NAME

GENERAL NOTES

SHEET NUMBER

SUBJECT PROPERTY IS LOCATED IN PANEL # 13085C0050C, DATED APRIL 4, 2018 AND IS IN THE BASE FLOOD ZONE X AND IS NOT IN A SPECIAL FLOOD HAZARD AREA. FLOOD ELEVATION IS NOT DETERMINED.





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DATE DESCRIPTION:	0 04/21/20 ISSUED FOR CLIENT REV.	1 04/28/20 ISSUED FOR CLIENT REV.	2 05/12/20 ISSUED FOR CONSTRUCTION	3 06/12/20 ISSUED FOR CONSTRUCTION	4 07/21/20 ISSUED FOR CONSTRUCTION	5 09/09/21 ISSUED FOR CONSTRUCTION	6 09/13/21 REVISED PER CLIENT COMMENT		
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CAJ: GA PEF005625



SITE NAME GA HWY52

SMW#: 20-0240

FUZE ID: 16093185 PSLC #: 500304


DESIGNED: JDS DRAWN: MEH CHECKED: BS

SHEET NAME

OVERALL SITE PLAN

SHEET NUMBER

C-2

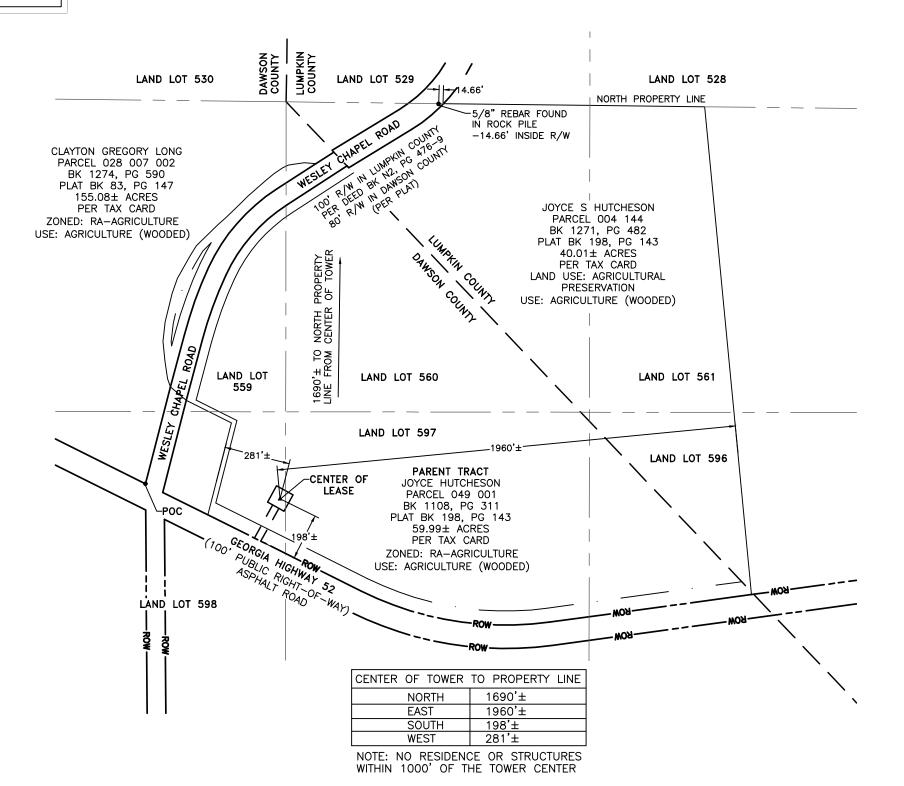

OVERALL PARENT TRACT

SUBJECT PROPERTY IS LOCATED IN PANEL # 13085C0050C, DATED APRIL 4, 2018 AND IS IN THE BASE FLOOD ZONE X AND IS NOT IN A SPECIAL FLOOD HAZARD AREA. FLOOD ELEVATION IS NOT DETERMINED.


200'

1" = 100' (11"x17")





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No. PEST206

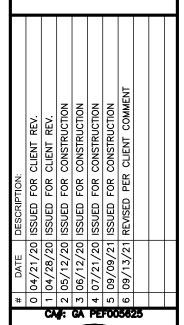SITE NAME
GA HWY52

09/13/2021

SMW#: 20-0240

FUZE ID: 16093185 PSLC #: 500304


DESIGNED: JDS
DRAWN: MEH
CHECKED: BS

SHEET NAME

OVERALL SITE PLAN

SHEET NUMBER

C-2.1

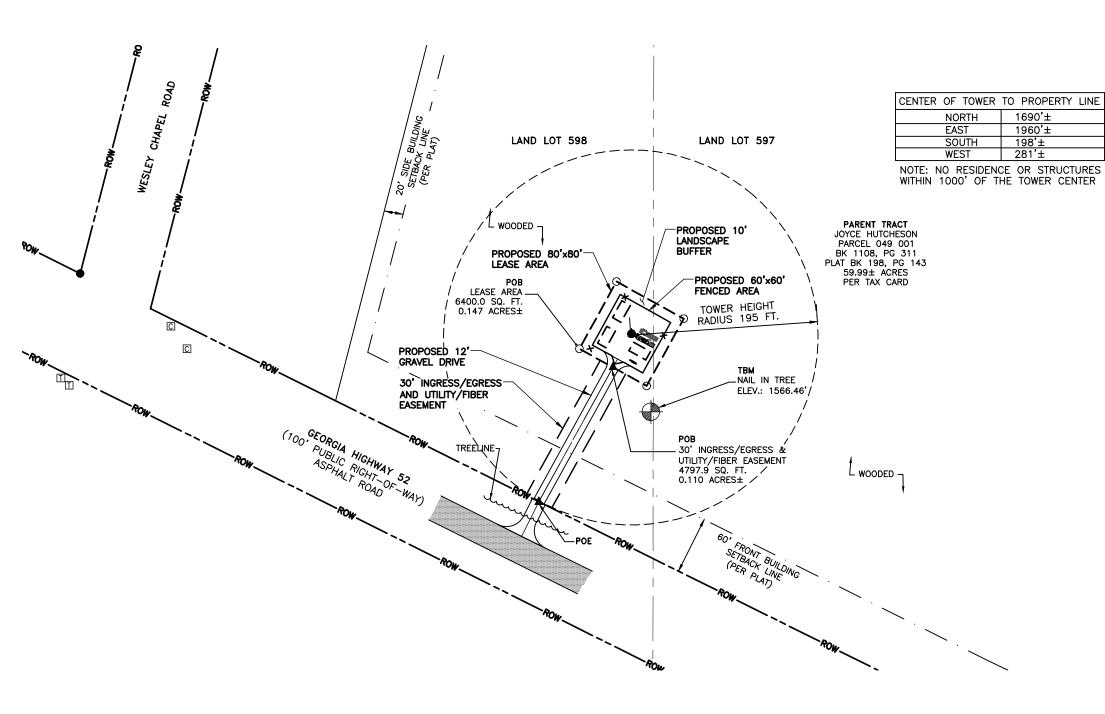

100'

 $1" = 50' (24" \times 36")$

OVERALL SITE PLAN

SUBJECT PROPERTY IS LOCATED IN PANEL # 13085C0050C, DATED APRIL 4, 2018 AND IS IN THE BASE FLOOD ZONE X AND IS NOT IN A SPECIAL FLOOD HAZARD AREA. FLOOD ELEVATION IS NOT DETERMINED.







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#	DATE	DESCRIPTION:
0	04/21/20	0 04/21/20 ISSUED FOR CLIENT REV.
-	04/28/20	1 04/28/20 ISSUED FOR CLIENT REV.
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4	07/21/20	4 07/21/20 ISSUED FOR CONSTRUCTION
5	09/09/21	5 09/09/21 ISSUED FOR CONSTRUCTION
9	09/13/21	6 09/13/21 REVISED PER CLIENT COMMENT





SITE NAME GA_HWY52

SMW#: 20-0240

FUZE ID: 16093185 PSLC #: 500304

DESIGNED: JDS DRAWN: MEH CHECKED: BS

SHEET NAME


OVERALL SITE PLAN

SHEET NUMBER C-2.2







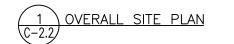

EXISTING TREES TO BE REMOVED WITHIN COMPOUND AND EASEMENT. CONTRACTOR TO FIELD VERIFY BEFORE CONSTRUCTION







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DESCRIPTION:	0 04/21/20 ISSUED FOR CLIENT REV.	04/28/20 ISSUED FOR CLIENT REV.	2 05/12/20 ISSUED FOR CONSTRUCTION	3 06/12/20 ISSUED FOR CONSTRUCTION	4 07/21/20 ISSUED FOR CONSTRUCTION	5 09/09/21 ISSUED FOR CONSTRUCTION	6 09/13/21 REVISED PER CLIENT COMMENT		
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SITE NAME GA_HWY52

SMW#: 20-0240

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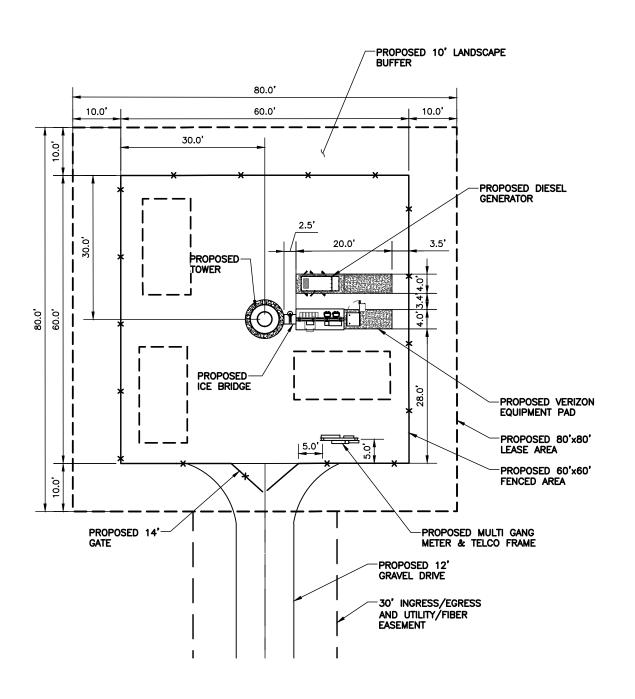
DESIGNED: JDS DRAWN: MEH CHECKED: BS

SHEET NAME

DETAILED SITE PLAN


SHEET NUMBER


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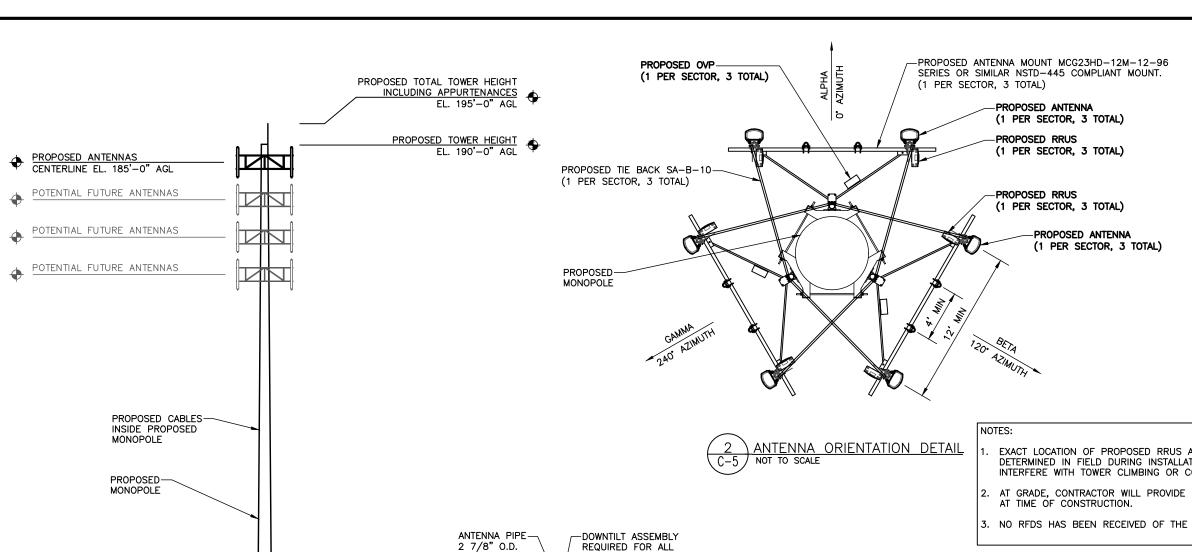










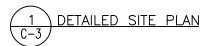


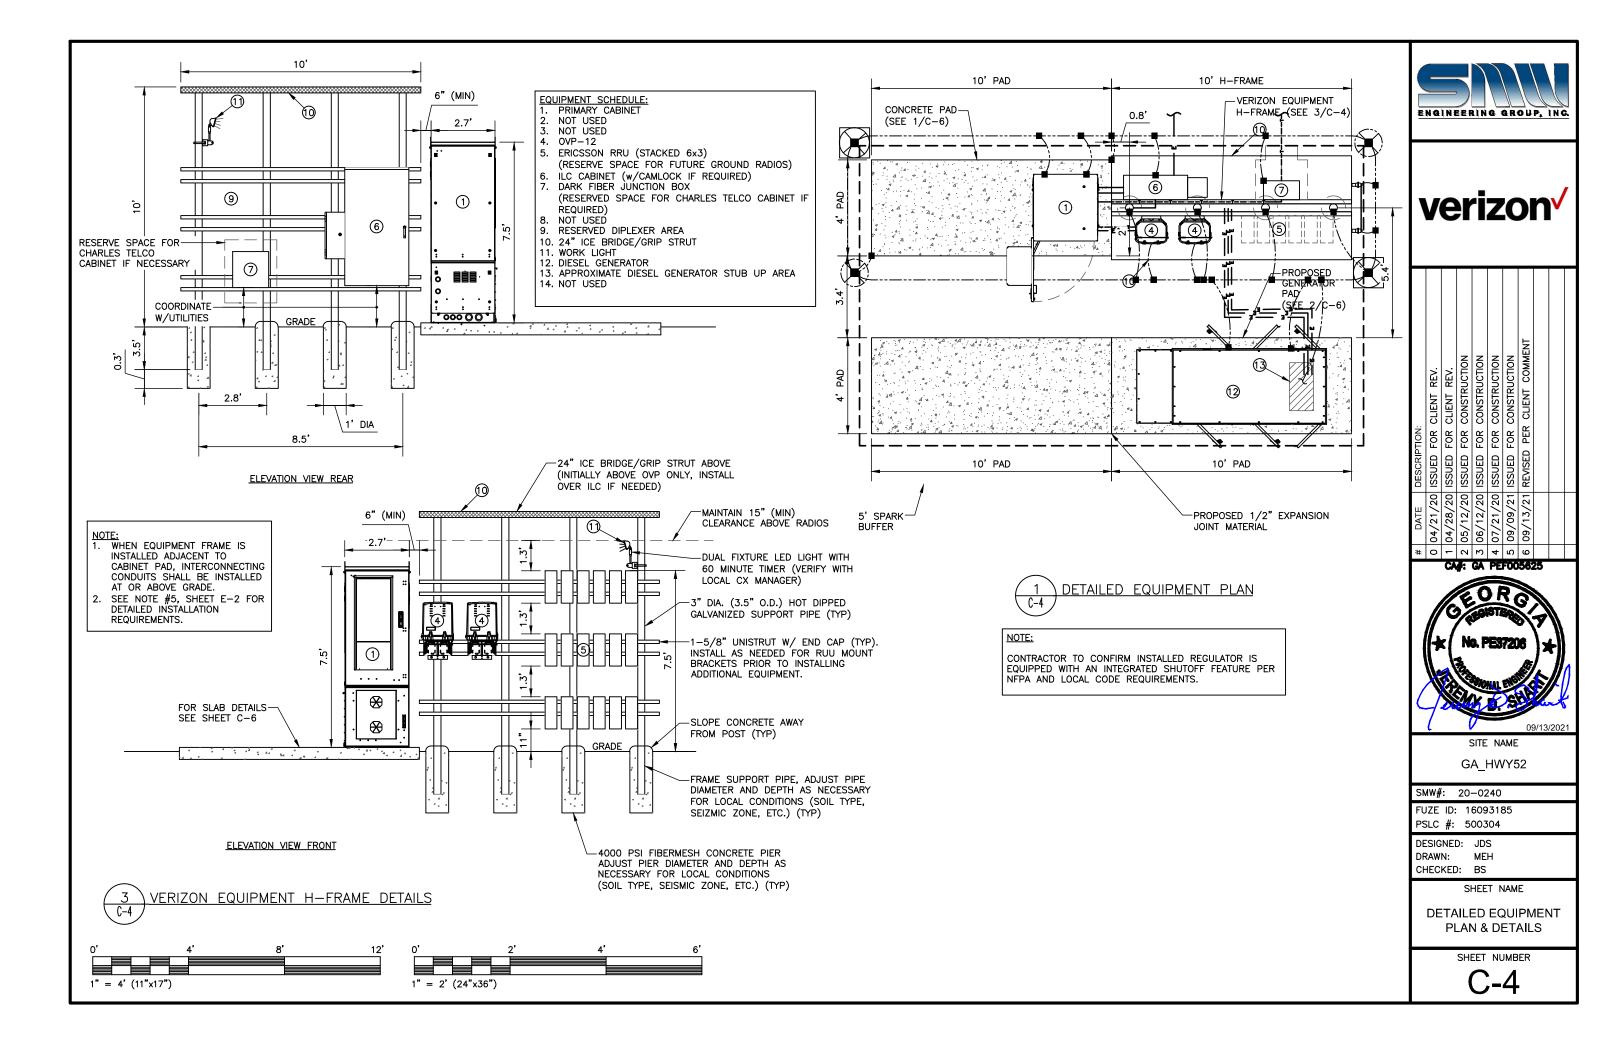

- EXACT LOCATION OF PROPOSED RRUS AND OVP BOX TO BE DETERMINED IN FIELD DURING INSTALLATION AS NOT TO INTERFERE WITH TOWER CLIMBING OR COAXIAL CABLE LADDER.
- 2. AT GRADE, CONTRACTOR WILL PROVIDE LOCATION OF OVP BOX
- NO RFDS HAS BEEN RECEIVED OF THE DATE ON THESE CDS.

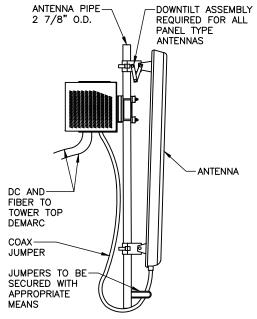

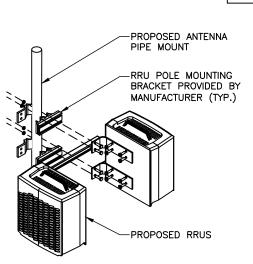

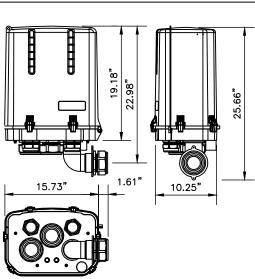

STRUCTURAL NOTES:

PROPOSED ICE BRIDGE-

PROPOSED

EQUIPMENT

AND PAD

STRUCTURAL CALCULATION PREPARED BY OTHERS. CONTRACTOR TO COORDINATE WITH REPRESENTATIVE TO OBTAIN A COPY.

NOT TO SCALE

TOWER ELEVATION

CONTRACTOR TO REFER TO TOWER STRUCTURAL ANALYSIS FOR ADDITIONAL LOADS. NO ERECTION OR MODIFICATION OF TOWER SHALL BE MADE WITHOUT APPROVAL OF STRUCTURAL ENGINEER.







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	#	DATE	DESCRIPTION:
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PE	4	07/21/20	4 07/21/20 ISSUED FOR CONSTRUCTION
FOO	2	09/09/21	5 09/09/21 ISSUED FOR CONSTRUCTION
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GA HWY52

SMW#: 20-0240


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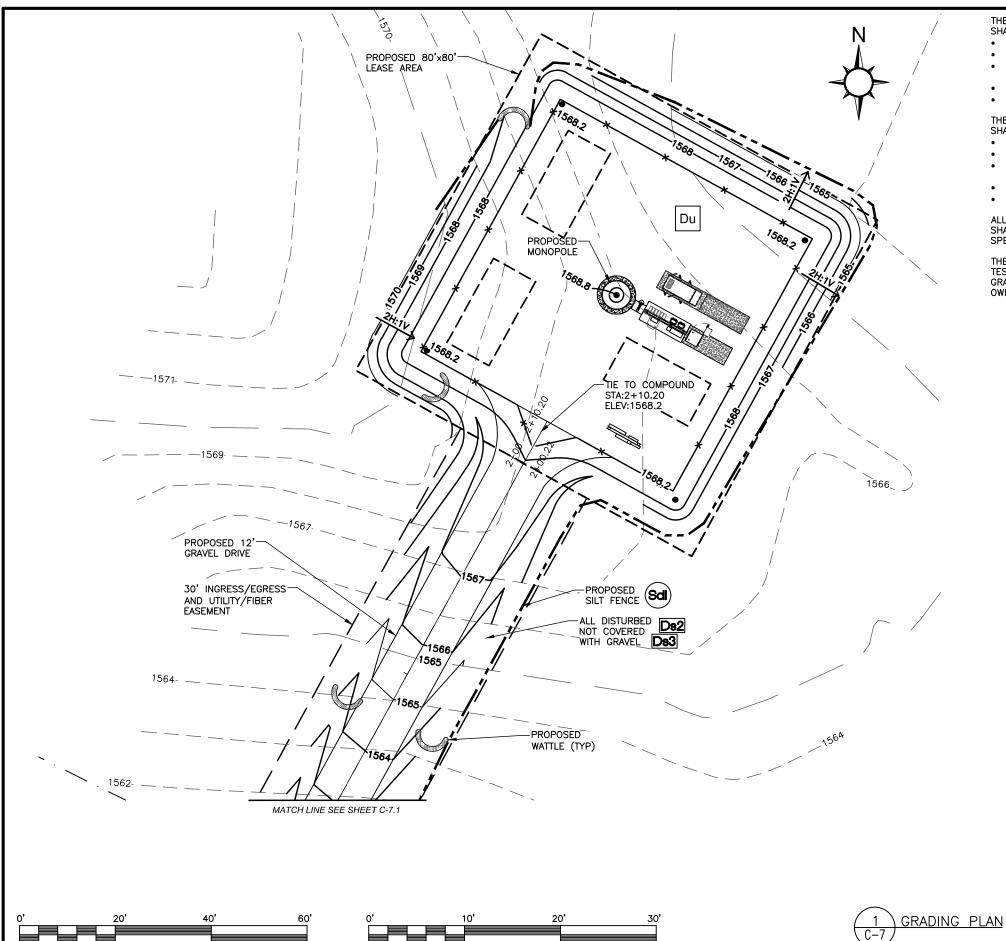
DESIGNED: JDS DRAWN: MFH CHECKED: BS

SHEET NAME

TOWER ELEVATION AND DETAILS

SHEET NUMBER



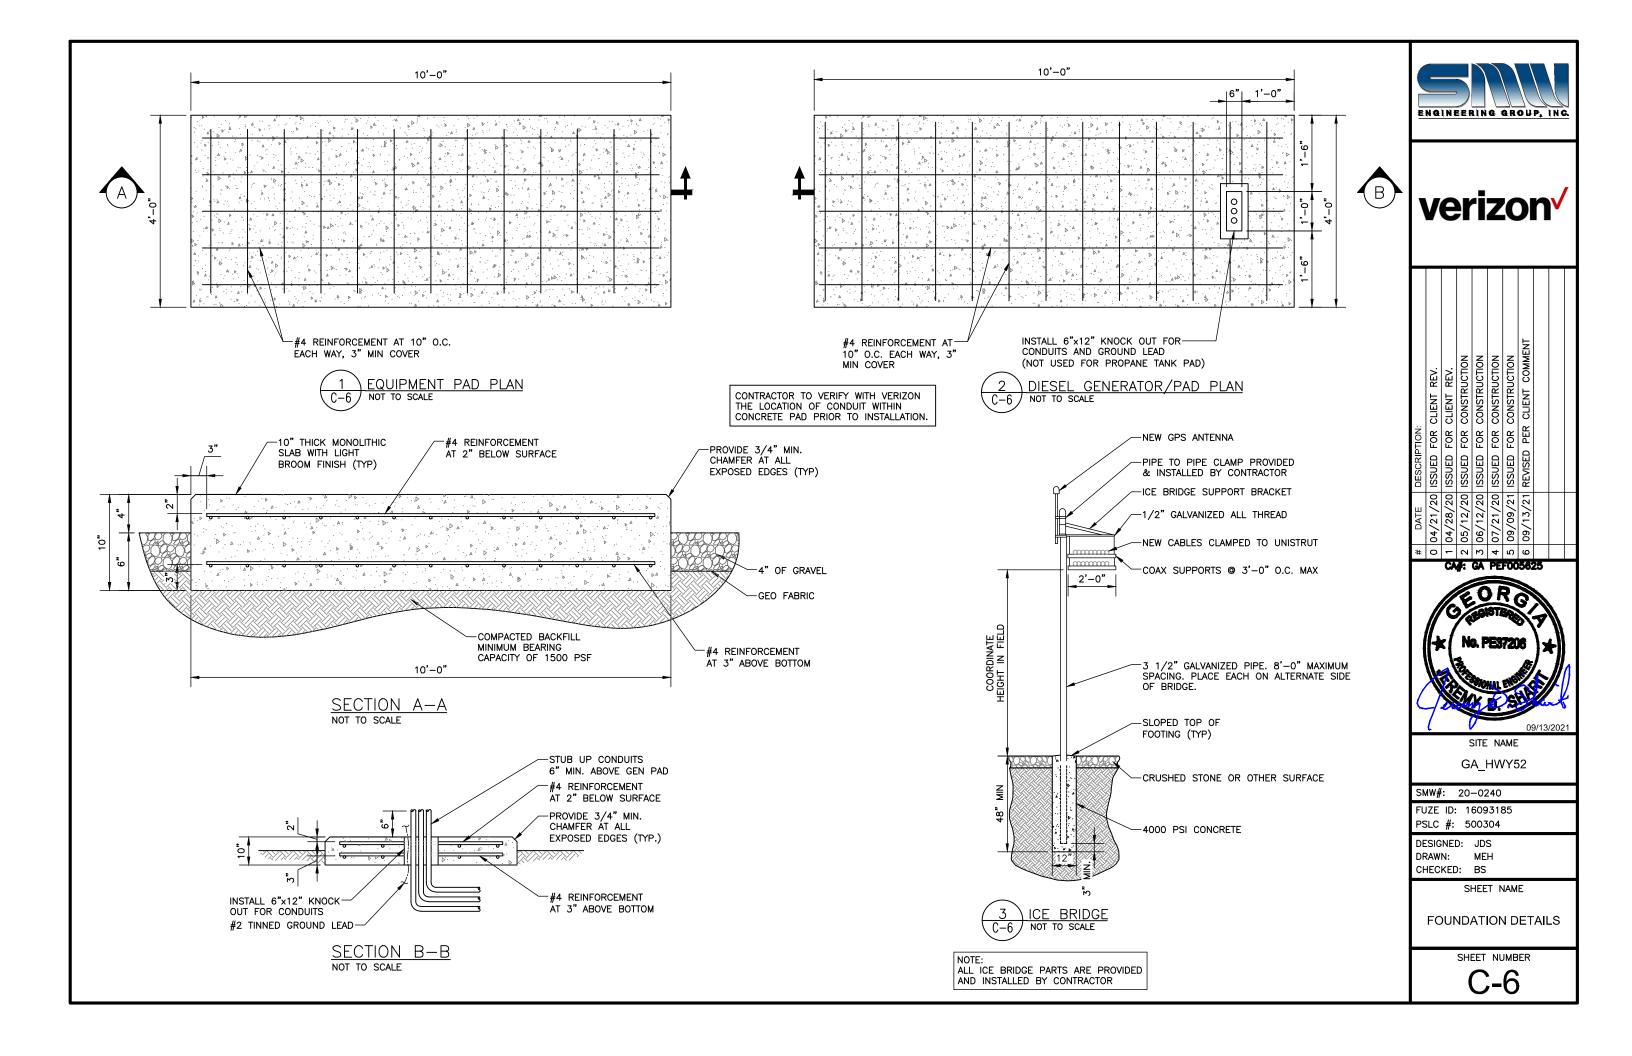

 $1" = 10' (24" \times 36")$

1" = 20' (11"x17")

THE PROPOSED ACCESS ROAD OUTSIDE THE FENCED COMPOUND SHALL BE SURFACES AS FOLLOWS:

- MINIMUM 4" CRUSHER RUN FINISHED DRIVE SURFACE
- MIRAPI 500X (OR EQUIVALENT) GEOFABRIC
- 2" TO 3" MINIMUM CRUSHER RUN OVER THE SUB BASE A
- 3" #3 GRAVEL ROLLED SUB-BASE COURSE
- SUBGRADE COMPACTED TO 95" STANDARD PROCTOR DENSITY

THE PROPOSED EQUIPMENT AREA INSIDE THE FENCED COMPOUND SHALL BE SURFACE AS FOLLOWS:

2" TO 3" MINIMUM #57 GRAVEL FINISHED SURFACE

- MIRAFI 500X (OR EQUIVALENT)
- 2" TO 3"MINIMUM CRUSHER RUN OVER THE SUB-BASE AND ROLLED
- 3" #3 GRAVEL ROLLED SUB BASE COURSE
- SUBGRADED COMPACTED TO 95" STANDARD PROCTOR DENSITY

ALL EXISTING SUB-GRADE AND CRUSHER RUN GRAVEL SURFACING SHALL BE COMPACTED 95% MINIMUM STANDARD PROCTOR DENSITY AS SPECIFIED BY ASTM D698 AND AASHTO T-99.

THE CONTRACTOR IS REQUIRED TO TEST AND SUBMIT COMPACTION TEST RESULTS FOR ALL EXISTING SUB-GRADE AND CRUSHER RUN GRAVEL SURFACING IN THE CLOSEOUT PACKAGE SUPPLIED TO TOWER

- CONSTRUCTION EXIT TO REDUCE OR ELIMINATE THE TRANSPORT OF MUD FROM THE CONSTRUCTION AREA ONTO PUBLIC RIGHT—OF—WAYS, STREETS, ALLEYS, SIDEWALKS, OR PARKING AREAS.
 - TYPE C SEDIMENT BARRIER TO PREVENT ANY SEDIMENT CARRIED BY SHEET FLOW FROM LEAVING THE SITE & ENTERING NATURAL DRAINAGE AREAS OR STORM DRAINAGE SYSTEMS.
- DS2 DISTURBED AREA STABILIZATION (TEMPORARY) TO ESTABLISH A TEMPORARY VEGETATIVE COVER WITH FAST GROWING SEEDS ON DISTURBED AREAS.
- DISTURBED AREA STABILIZATION (PERMANENT) TO ESTABLISH A PERMANENT VEGETATIVE COVER SUCH AS TREES, SHRUBS, VINES, GRASSES, SOD, OR LEGUMES ON DISTURBED AREA.
- DISTURBED AREA DUST CONTROL TO CONTROL THE SURFACE AND AIR MOMENT OF DUST ON CONSTRUCTION SITES, ROADWAYS, AND SIMILAR

CONTRACTOR TO OBTAIN WRITTEN PERMISSION FOR GRADING OUTSIDE LEASE AREA PRIOR TO CONSTRUCTION





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SITE NAME GA HWY52

SMW#: 20-0240

FUZE ID: 16093185 PSLC #: 500304


DESIGNED: JDS DRAWN: MEH CHECKED: BS

SHEET NAME

GRADING, SEDIMENT & **EROSION CONTROL PLAN**

SHEET NUMBER

C-7

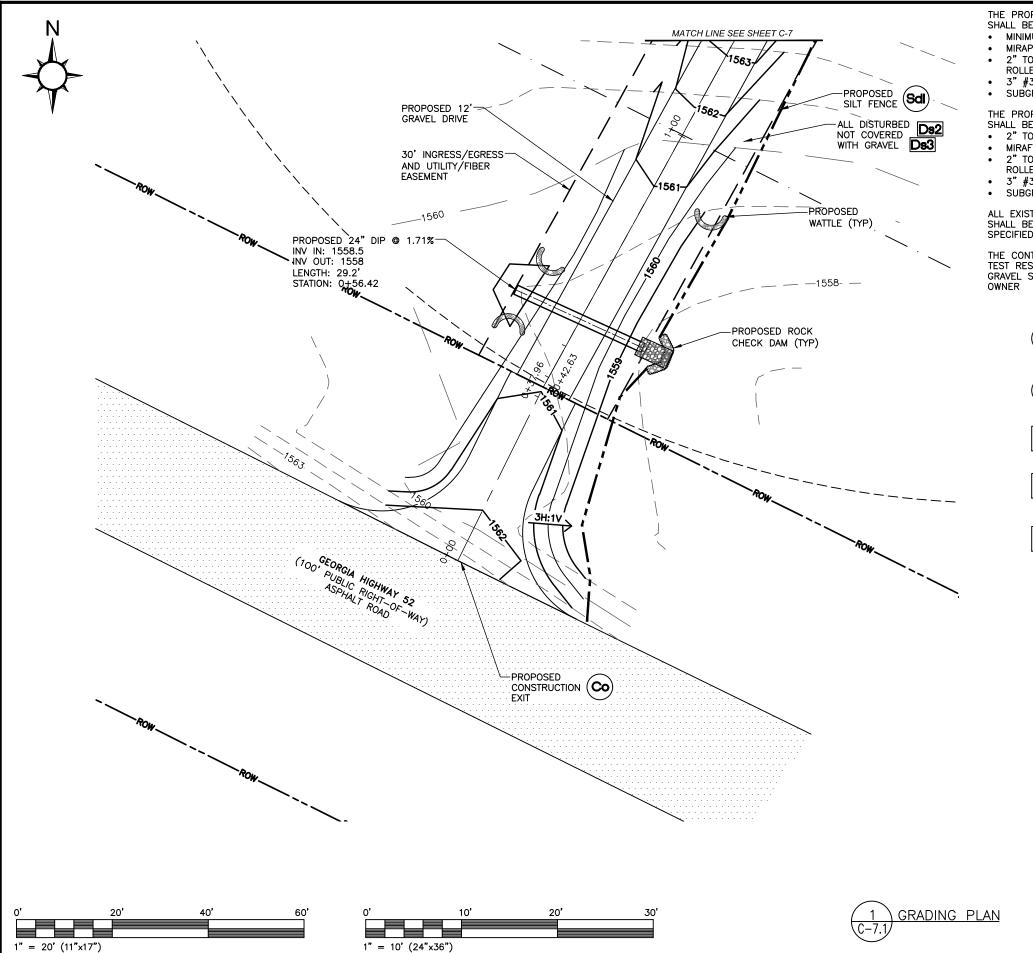

THE PROPOSED ACCESS ROAD OUTSIDE THE FENCED COMPOUND SHALL BE SURFACES AS FOLLOWS:

- MINIMUM 4" CRUSHER RUN FINISHED DRIVE SURFACE
- MIRAPI 500X (OR EQUIVALENT) GEOFABRIC
- 2" TO 3" MINIMUM CRUSHER RUN OVER THE SUB BASE A
- 3" #3 GRAVEL ROLLED SUB-BASE COURSE
- SUBGRADE COMPACTED TO 95" STANDARD PROCTOR DENSITY

THE PROPOSED EQUIPMENT AREA INSIDE THE FENCED COMPOUND SHALL BE SURFACE AS FOLLOWS:

2" TO 3" MINIMUM #57 GRAVEL FINISHED SURFACE

- MIRAFI 500X (OR EQUIVALENT)
- 2" TO 3"MINIMUM CRUSHER RUN OVER THE SUB-BASE AND
- 3" #3 GRAVEL ROLLED SUB BASE COURSE
- SUBGRADED COMPACTED TO 95" STANDARD PROCTOR DENSITY

ALL EXISTING SUB-GRADE AND CRUSHER RUN GRAVEL SURFACING SHALL BE COMPACTED 95% MINIMUM STANDARD PROCTOR DENSITY AS SPECIFIED BY ASTM D698 AND AASHTO T-99.

THE CONTRACTOR IS REQUIRED TO TEST AND SUBMIT COMPACTION TEST RESULTS FOR ALL EXISTING SUB-GRADE AND CRUSHER RUN GRAVEL SURFACING IN THE CLOSEOUT PACKAGE SUPPLIED TO TOWER

- CONSTRUCTION EXIT TO REDUCE OR ELIMINATE THE TRANSPORT OF MUD FROM THE CONSTRUCTION AREA ONTO PUBLIC RIGHT—OF—WAYS, STREETS, ALLEYS, SIDEWALKS, OR PARKING AREAS.
- TYPE C SEDIMENT BARRIER TO PREVENT ANY SEDIMENT CARRIED BY SHEET FLOW FROM LEAVING THE SITE & ENTERING NATURAL DRAINAGE AREAS OR STORM DRAINAGE SYSTEMS.
- DS2 DISTURBED AREA STABILIZATION (TEMPORARY) TO ESTABLISH A TEMPORARY VEGETATIVE COVER WITH FAST GROWING SEEDS ON DISTURBED AREAS.
- DISTURBED AREA STABILIZATION (PERMANENT) TO ESTABLISH A PERMANENT VEGETATIVE COVER SUCH AS TREES, SHRUBS, VINES, GRASSES, SOD, OR LEGUMES ON DISTURBED AREA.
- DISTURBED AREA DUST CONTROL TO CONTROL THE SURFACE AND AIR MOMENT OF DUST ON CONSTRUCTION SITES, ROADWAYS, AND SIMILAR

CONTRACTOR TO OBTAIN WRITTEN PERMISSION FOR GRADING OUTSIDE LEASE AREA PRIOR TO CONSTRUCTION





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SITE NAME GA HWY52

SMW#: 20-0240

FUZE ID: 16093185 PSLC #: 500304


DESIGNED: JDS DRAWN: MEH CHECKED: BS

SHEET NAME

GRADING, SEDIMENT & **EROSION CONTROL PLAN**


SHEET NUMBER

C-7.1

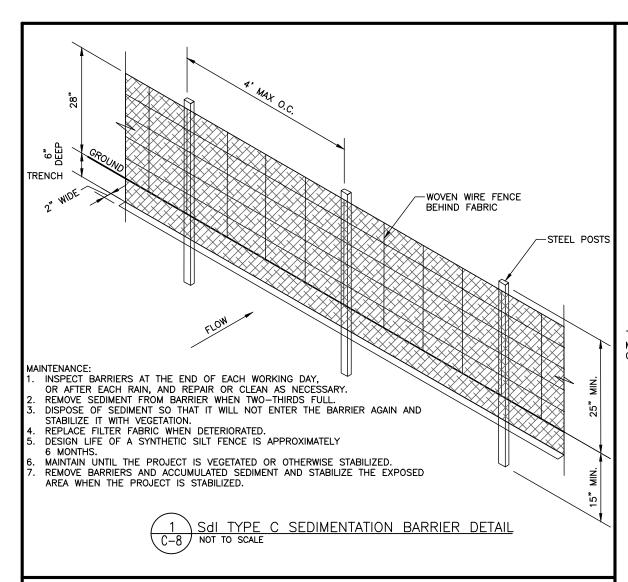



MAINTENANCE:

- 1. PERIODICALLY DRESS WITH 1.5"-3.5" STONE.
- 2. MAINTAIN IN A CONDITION THAT WILL PREVENT TRACKING OR FLOW OF MUD ONTO PUBLIC RIGHTS-OF-WAY.

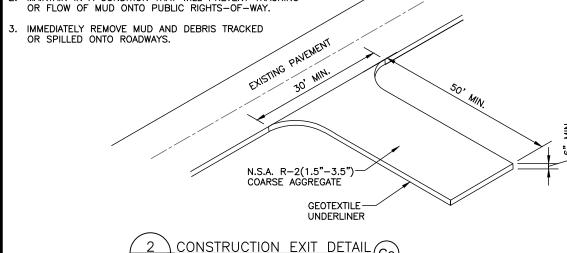

WATTLE DETAILS

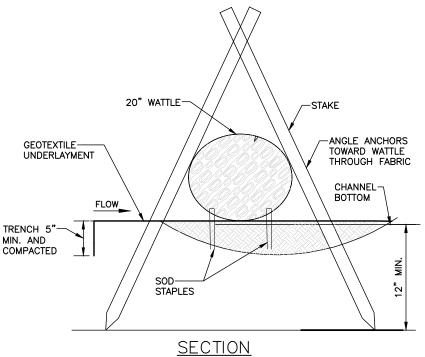


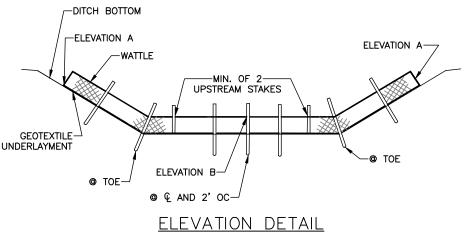


NOTE: END POINTS A MUST BE HIGHER THAN FLOWLINE POINT B


- 1. MINIMUM RECOMMENDED PLACEMENT INTERVAL BETWEEN WATTLE DITCH CHECK IS 50 FEET UNLESS SHOWN OTHERWISE ON THE PLANS OR APPROVED BY THE ENGINEER.
- 2. ANCHORING STAKES SHALL BE SIZED, SPACED, DRIVEN, AND BE OF A MATERIAL THAT EFFECTIVELY SECURES THE CHECK. STAKE SPACING SHALL BE A MAXIMUM OF TWO FELT.
- 3. SECURE GEOTEXTILE UNDERLAYMENT BY PLACING STAPLES 18 INCHES APART ALONG TH CHANNEL EDGES AND DOWN THE CENTER OF THE CHANNEL. SPACE STAPLES 10 INCHE APART ACROSS THE UPSTREAM AND DOWNSTREAM EDGES.
- 4. PLACE STAPLES ON BOTH SIDES OF WATTLE AT 10" SPACING.

L = THE DISTANCE SUCH THAT POINTS A AND B ARE OF EQUAL ELEVATION.

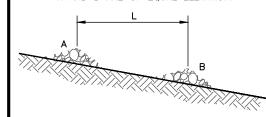

SPACING CHECK IN BETWEEN DAMS

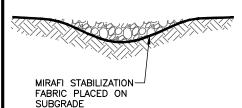

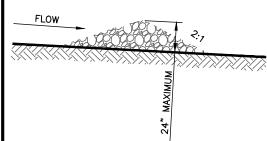

NOTES:

- CHECK DAMS TO BE CONSTRUCTED OF GRADED SIZE 2 10 INCH STONE. MECHANICAL OR HAND PLACEMENT SHALL BE REQUIRED TO INSURE COMPLETE COVERAGE OF ENTIRE WIDTH OF DITCH OR SWALE AND THAT CENTER OF DAM IS LOWER THAN EDGES.
- 2. SEDIMENT TO BE REMOVED WHEN A LEVEL OF 1/2 THE ORIGINAL DAM HEIGHT OR LESS IS REACHED. REMOVE CHECK DAMS AT COMPLETION OF WORK.







CA#: GA PEF005625	# 0 1 2 M 4 W 0	DATE 04/21/20 04/28/20 05/12/20 06/12/20 07/21/20 09/09/21	# DATE DESCRIPTION: 0 04/21/20 ISSUED FOR CLIENT REV. 1 04/28/20 ISSUED FOR CLIENT REV. 2 05/12/20 ISSUED FOR CONSTRUCTION 3 06/12/20 ISSUED FOR CONSTRUCTION 4 07/21/20 ISSUED FOR CONSTRUCTION 5 09/09/21 ISSUED FOR CONSTRUCTION 6 09/13/21 REVISED PER CLIENT COMMENT
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GA HWY52


SITE NAME

SMW#: 20-0240 FUZE ID: 16093185 PSLC #: 500304

DESIGNED: JDS DRAWN: MEH CHECKED: BS

> SHEET NAME **GRADING, SEDIMENT & EROSION CONTROL DETAILS**

> > SHEET NUMBER

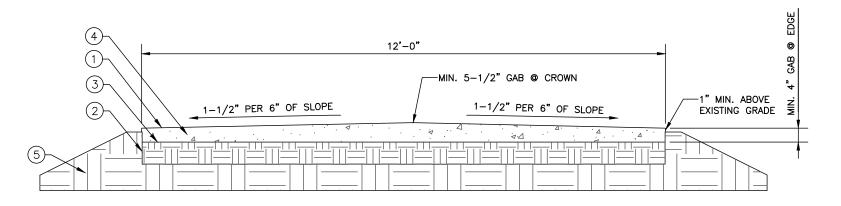


GRAVEL ROAD DETAIL

TYPICAL GRAVEL ROAD CROSS SECTION

CONTRACTOR SHALL BE RESPONSIBLE FOR CLEARING & GRUBBING THE CONSTRUCTION SITE AND ROADWAY AREAS. THE CONTRACTOR SHALL COMPLY, WHEN NECESSARY, WITH THE RECOMMENDATIONS CONTAINED WITHIN THE GEOTECHNICAL REPORT PREPARED FOR THIS SITE FOR SITE WORK PREPARATION & FOUNDATION WORK.

- 1. MINIMUM 4" CRUSHER RUN FINISHED DRIVING SURFACE
- 2. MIRAFI 500X (OR EQUIVALENT) GEOFABRIC
- 3. 2" TO 3" MINIMUM CRUSHER RUN OVER THE SUB-BASE AND ROLLED
- 4. 3" #3 GRAVEL ROLLED SUB-BASE COURSE
- 5. SUBGRADE COMPACTED TO 95% STANDARD PROCTOR DENSITY

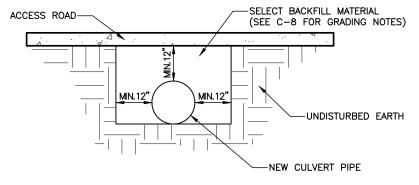

CULVERT DETAIL



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DESCRIPTION:	0 04/21/20 ISSUED FOR CLIENT REV.	1 04/28/20 ISSUED FOR CLIENT REV.	2 05/12/20 ISSUED FOR CONSTRUCTION	3 06/12/20 ISSUED FOR CONSTRUCTION	4 07/21/20 ISSUED FOR CONSTRUCTION	5 09/09/21 ISSUED FOR CONSTRUCTION	6 09/13/21 REVISED PER CLIENT COMMENT		
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CA#: GA PEF005625



GA_HWY52

SMW#: 20-0240

FUZE ID: 16093185 PSLC #: 500304

DESIGNED: JDS DRAWN: MEH CHECKED: BS

SHEET NAME
GRADING, SEDIMENT &

EROSION CONTROL DETAILS

SHEET NUMBER

C-8.1

PIEDMONT VEGETATIVE COVERS GENERAL

CALENDAR	TEMPORARY	APPLICATION RATE/ACRE	PERMANENT	APPLICATION RATE/ACRE
MONTH 1. JANUARY	SEED RYE GRASS	20-40 LB.	SEED UNHULLED BERMUDA SERICEA LESPEDEZA	8-10 LB.
2. FEBRUARY			UNHULLED BERMUDA SERICEA LESPEDEZA FESCUE	
3. MARCH	RYE ANNUAL LESPEDZA WEEPING LOVE GRASS	2-3 BU. 20-25 LB. 4-6 LB.	UNHULLED BERMUDA SERICEA LESPEDEZA FESCUE	8-10 LB. 30-40 LB. 30-50 LB.
4. APRIL	RYE BROWN TOP MULLET ANNUAL LESPEDZA SUDAN ANNUAL	2-3 BU. 30-40 LB. 20-25 LB. 35 LB.		4-6 LB. 5-6 LB. 40-60 LB.
5. MAY	WEEPING LOVE GRASS SUDAN GRASS BROWN TOP MULLET	4-6 BU. 35 LB. 30-40 LB.	WEEPING LOVE GRASS HULLED BERMUDA BAJA	4-6 LB. 5-6 LB. 40-60 LB.
6. JUNE	WEEPING LOVE GRASS SUDAN GRASS BROWN TOP MULLET	4-6 LB. 35 LB. 30-40 LB.	WEEPING LOVE GRASS HULLED BERMUDA BAJA	
7. JULY	WEEPING LOVE GRASS SUDAN GRASS BROWN TOP MULLET	4-6 LB. 35 LB. 30-40 LB.		
8. AUGUST	RYE GRASS WEEPING LOVE GRASS	40-50 LB. 4-6 LB.		
9. SEPTEMBER			TALL FESCUE	30-50 LB.
10. OCTOBER	WHEAT	2-3 BU.	UNHULLED BERMUDA SERICEA LESPEDEZA FESCUE	
11. NOVEMBER	WHEAT	2-3 BU.	UNHULLED BERMUDA SERICEA LESPEDEZA FESCUE	8-10 LB. 30-40 LB. 30-50 LB.
12. DECEMBER	RYE RYE GRASS WHEAT	2-3 BU. 40-50 LB. 2-3 BU.	UNHULLED BERMUDA SERICEA LESPEDEZA FESCUE	8-10 LB. 30-40 LB. 30-50 LB.

- USE A MINIMUM OF 40 LBS. SCARIFIED SEED. THE REMAINING MAY BE UNSCARIFIED, CLEAN HULLED SEED.
- 2. USE EITHER COMMON SERIAL OR INTERSTATE SERICEA

THIS VEGETATIVE PLAN WILL BE CARRIED OUT IN ROAD CUT AND FILL SLOPES, SHOULDERS, AND OTHER CRITICAL AREAS CREATED BY CONSTRUCTION. SEEDING WILL BE DONE AS SOON AS CONSTRUCTION IN AN AREA IS COMPLETED. PLANTINGS WILL BE MADE TO CONTROL EROSION, TO REDUCE DAMAGE FROM SEDIMENT AND RUNOFF TO DOWNSTREAM AREAS, AND TO IMPROVE THE SAFETY AND BEAUTY OF THE DEVELOPMENT ARFA.

SOIL CONDITIONS

DUE TO GRADING AND CONSTRUCTIONS, THE AREAS TO BE TREATED ARE MAINLY SUBSOIL AND SUBSTRATES. FERTILITY IS LOW AND THE PHYSICAL CHARACTERISTICS OF THE EXPOSED MATERIAL ARE UNFAVORABLE TO ALL BUT THE MOST HARDY PLANTS.

TREATMENT SPECIFICATIONS

HYDRAULIC SEEDING EQUIPMENT: WHEN HYDRAULIC SEEDING AND FERTILIZING EQUIPMENT IS USED, NO GRADING AND SHAPING OF SEEDED PREPARATIONS WILL BE REQUIRED. THE FERTILIZER, SEED, AND WOOD CELLULOSE FIBER MULCH WILL BE MIXED WITH WATER AND SUPPLIED IN A SLURRY. ALL SLURRY INGREDIENTS MUST BE COMBINED TO FORM A HOMOGENEOUS MIXTURE, AND SPREAD UNIFORMLY OVER THE AREA WITH ONE HOUR AFTER MIXTURE IS MADE. STRAW OR HAY MULCH AND ASPHALT EMULSION WILL BE APPLIED WITH BLOWER—TYPE MULCH SPREADING EQUIPMENT WITHIN 24 HOURS AFTER SEEDING. THE MULCH WILL BE SPREAD UNIFORMLY OVER THE AREA, LEAVING ABOUT 25 PERCENT OF THE GROUND SURFACE EXPOSED. THE PER ACRE APPLICATION RATES ARE AS FOLLOWS:

A. SEEDING WITH MULCH: (HYDRAULIC SEEDING EQUIPMENT ON SLOPES 3:1 AND STEEPER)

AGRICULTURAL LIMESTONE #75	400 LBS/ACRE
FERTILIZER, 05-10-15	500 LBS/ACRE
MULCH (STRAW OR HAY)	5000 LBS/ACRE
MULCH (WOOD CELLULOSE FIBER)	1000 LBS/ACRE

SEED SPECIES	APPLICATION RATE/ACRE	PLANTING DATES
SERICIA LESPEDEZA, SCARIFIED WEEPING LOVE GRASS, OR COMMON BERMUDA, HULLED	60 LBS. 4 LBS. 6 LBS.	3/1-6/15
FESCUE SERICEA LESPEDEZA, UNCERTIFIED	40 LBS. 60 LBS.	4/1-10/31
FESCUE SERICEA LESPEDEZA, UNCERTIFIED RYE	40 LBS. 75 LBS. 50 LBS.	11/1-12/28
HAY MULCH FOR TEMPORARY COVER	5000 LBS.	6/15-8/31

B. TOP DRESSING: APPLY WHEN PLANTS ARE 2 TO 4 INCHES TALL FERTILIZER (AMMONIUM NITRATE 33.5%) 300 LBS/ACRE

C. SECOND YEAR TREATMENT:

FERTILIZER (0-20-20 OR EQUIVALENT) 500 LBS/ACRE

THIS VEGETATIVE PLAN WILL BE CARRIED OUT IN ROAD CUT AND FILL SLOPES, SHOULDERS, AND OTHER CRITICAL AREAS CREATED BY CONSTRUCTION. SEEDING WILL BE DONE AS SOON AS CONSTRUCTION IN AN AREA IS COMPLETED. PLANTINGS WILL BE MADE TO CONTROL EROSION, TO REDUCE DAMAGE FROM SEDIMENT AND RUNOFF TO DOWNSTREAM AREAS, AND TO IMPROVE THE SAFETY AND BEAUTY OF THE DEVELOPMENT

SOIL CONDITIONS

DUE TO GRADING AND CONSTRUCTIONS, THE AREAS TO BE TREATED ARE MAINLY SUBSOIL AND SUBSTRATES. FERTILITY IS LOW AND THE PHYSICAL CHARACTERISTICS OF THE EXPOSED MATERIAL ARE UNFAVORABLE TO ALL BUT THE MOST HARDY PLANTS.

TREATMENT SPECIFICATIONS

CONVENTIONAL SEEDING EQUIPMENT: GRADE, SHAPE, AND SMOOTH WHERE NEEDED TO PROVIDE FOR SAFE EQUIPMENT OPERATION AT SEEDING TIME AND FOR MAINTENANCE PURPOSES. THE LIME AND FERTILIZER IN DRY FORM WILL SPREAD UNIFORMLY OVER THE AREA IMMEDIATELY BEFORE SEEDBED PREPARATION. A SEEDBED WILL BE PREPARED BY SCARIFYING TO A DEPTH OF 1 TO 4 INCHES AS DETERMINED ON SITE. THE SEEDBED MUST BE WELL PULVERIZED, SMOOTHED, AND FIRMED. SEEDING WILL BE DONE WITH A CULTIPACKER—SEEDER, ROTARY SEEDER, OR OTHER MECHANICAL OR HAND SEEDER. SEED WILL BE DISTRIBUTED UNIFORMLY OVER A FRESH PREPARED SEEDBED AND COVERED LIGHTLY OVER THE AREA, LEAVING ABOUT 25 PERCENT OF THE GROUND SURFACE EXPOSED. MULCH WILL BE SPREAD EITHER BY BLOWER—TYPE MULCH EQUIPMENT OR BY HAND AND ANCHORED IMMEDIATELY AFTER IT WAS SPREAD. A DISK HARROW WITH THE DISK SET STRAIGHT OR A SPECIAL PACKER DISK MAY BE USED TO PRESS THE MULCH INTO THE SOIL. THE PER ACRE APPLICATION ARE AS FOLLOWS:

A. SEEDING WITH MULCH: (CONVENTIONAL SEEDING EQUIPMENT ON SLOPES LESS THAN 3:1)

AGRICULTURAL LIMESTONE #15 400 LBS/ACRE FERTILIZER, 5-10-15 1500 LBS/ACRE MULCH (STRAW OR HAY) 5000 LBS/ACRE

SEED SPECIES	APPLICATION RATE/ACRE	
COMMON BERMUDA, HULLED	10 LBS.	
FESCUE	50 LBS.	
FESCUE RYE GRASS	50 LBS. 50 LBS.	
HAY MULCH FOR TEMPORARY COVER	5000 LBS.	

- B. TOP DRESSING: APPLY WHEN PLANTS ARE 2 TO 4 INCHES TALL FERTILIZER (AMMONIUM NITRATE 33.5%) 300 LBS/ACRE
- C. SECOND YEAR TREATMENT:

FERTILIZER (0-20-20 OR EQUIVALENT) 800 LBS/ACRE



DISTURBED AREA STABILIZATION (WITH TEMPORARY SEEDING)



DISTURBED AREA STABILIZATION (WITH PERMANENT VEGETATION)







SITE NAME GA HWY52

SMW#: 20-0240

FUZE ID: 16093185 PSLC #: 500304

DESIGNED: JDS DRAWN: MEH CHECKED: BS

SHEET NAME

GRADING, SEDIMENT & EROSION CONTROL VEGETATION SPECS

SHEET NUMBER

C-9



OWNER CONTACT SIGN

WHITE BACKGROUND, BLACK/RED LETTERING MOUNTING LOCATION: GATE QUANTITY: 2






AUTHORIZED PERSONNEL SIGN


WHITE/BLUE BACKGROUND, WHITE/BLACK LETTERING MOUNTING LOCATION: GATE & BASE OF TOWER QUANTITY: 1

WHERE ACCESS GATE INSTALLED (QTY. 2)

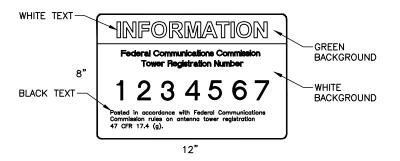

FCC REGISTRATION SIGN

WHITE/GREEN BACKGROUND, WHITE/BLACK LETTERING MOUNTING LOCATION: GATE & BASE OF TOWER

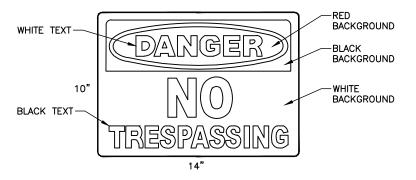

DANGER NO TRESPASSING SIGN

WHITE/BLACK BACKGROUND, BLACK/WHITE LETTERING MOUNTING LOCATION: GATE & BASE OF TOWER QUANTITY: 1

WHERE ACCESS GATE INSTALLED (QTY. 2)



1 NOTICE RF SIGN (BLUE)

WHITE/BLUE BACKGROUND, WHITE/BLACK LETTERING MOUNTING LOCATION: GATE & CENTERLINE OF FENCING AROUND SITE. (QTY. 4) WHERE ACCESS GATE INSTALLED (QTY. 5)





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	0	04/21/20	0 04/21/20 ISSUED FOR CLIENT REV.
CA	-	04/28/20	1 04/28/20 ISSUED FOR CLIENT REV.
# :	7	05/12/20	2 05/12/20 ISSUED FOR CONSTRUCTION
GΑ	ы	06/12/20	3 06/12/20 ISSUED FOR CONSTRUCTION
PE	4	07/21/20	4 07/21/20 ISSUED FOR CONSTRUCTION
FO0	2	09/09/21	5 09/09/21 ISSUED FOR CONSTRUCTION
562	9	09/13/21	6 09/13/21 REVISED PER CLIENT COMMENT
25			

09/13/2021

GA HWY52

SITE NAME

SMW#: 20-0240 FUZE ID: 16093185


PSLC #: 500304 DESIGNED: JDS DRAWN: MEH

CHECKED: BS SHEET NAME

SITE SIGNAGE

SHEET NUMBER

C-10

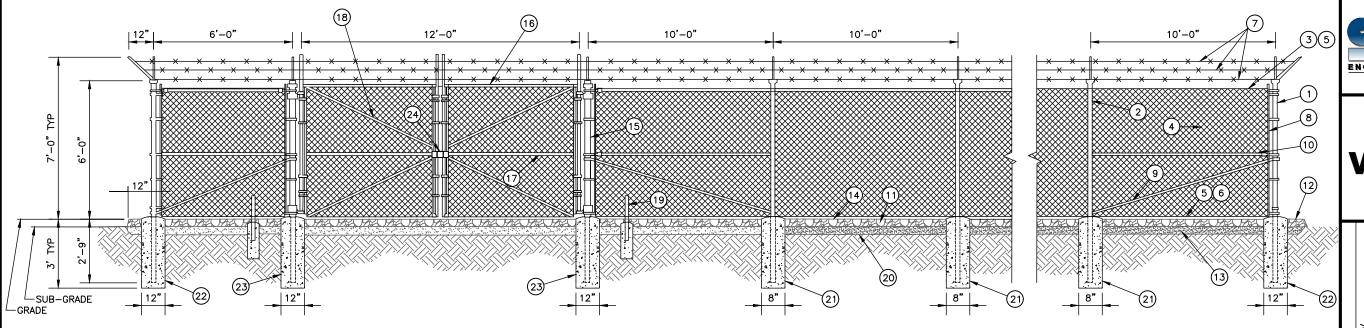

FENCE DETAIL

C-11 NOT TO SCALE



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DATE DESCRIPTION: 0 04/21/20 ISSUED FOR CLIENT REV. 1 04/28/20 ISSUED FOR CLIENT REV. 2 05/12/20 ISSUED FOR CONSTRUCTION 3 06/12/20 ISSUED FOR CONSTRUCTION 4 07/21/20 ISSUED FOR CONSTRUCTION 5 09/09/21 ISSUED FOR CONSTRUCTION 6 09/13/21 REVISED FOR CONSTRUCTION 6 09/13/21 REVISED PER CLIENT COMMENT

CAF: GA PEF005625



GA_HWY52

SITE NAME

SMW#: 20-0240

FUZE ID: 16093185 PSLC #: 500304

DESIGNED: JDS
DRAWN: MEH
CHECKED: BS

SHEET NAME

FENCE DETAILS

C-11

GENERAL NOTES:

- 1. INSTALL FENCING PER ASTM F-567
- 2. INSTALL SWING GATES PER ASTM-900
- 3. LOCAL ORDINANCE OF BARBED WIRE PERMIT REQUIREMENT SHALL BE COMPLIED IF REQUIRED
- 4. CORNER POST & GATE PIPE SIZES ARE INDUSTRY STANDARDS. ALL PIPE TO BE GALV. (HOT DIP, ASTM A120 GRADE "A" STEEL) ALL GATE FRAMES SHALL BE WELDED, ALL WELDING SHALL BE COATED WITH (3) COATS OF COLD GALV, (OR EQUAL)
- 5. ALL OPEN POSTS SHALL HAVE END-CAPS
- 6. USE GALVANIZED HOG-RING WIRE TO MOUNT ALL SIGNS
- 7. ALL SIGNS MUST BE MOUNTED ON INSIDE OF FENCE FABRIC
- 8. USE COMMERCIAL GRADE MATERIALS ONLY


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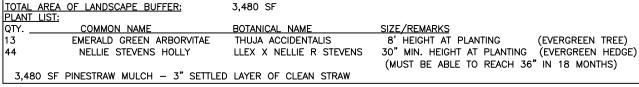
- ① CORNER END OR PULL POST 3" NOMINAL SCHEDULE 40 PIPE.
- 2 LINE POST: 2 1/2" SCHEDULE 40 PIPE, PER ASTM-F1083. LINE POSTS SHALL BE EQUALLY SPACED AT MAXIMUM 10'-0" O.C.
- 3 TOP RAIL & BRACE RAIL: 1 1/2" PIPE, PER ASTM-F1083
- FABRIC: 9GA CORE WIRE SIZE 2' MESH, CONFORMING TO ASTM-A392
- TIE WIRE: MINIMUM II GA GALVANIZED STEEL AT POSTS AND RAILS A SINGLE WRAP OF FABRIC TIE END AT TENSION WIRE BU HOG RINGS SPACED AX. AT 24" O.C.
- 6 TENSION WIRE: 9GA GALVANIZED STEEL
- 7 BARBED WIRE: DOUBLE STRAND 12 1/2" OD TWISTED WIRE TO MATCH WITH FABRIC 14GA, 4PT. BARBS SPACE ON APPROX 6" CENTERS
- 8 STRETCHER BAR
- 9 3/8" DIAGONAL ROD WITH GALVANIZED STEEL TURNBUCKLE OR DIAGONAL THREADED ROD
- 10 FENCE CORNER POST BRACE: 1 5/8" DIA. EACH CORNER EACH WAY
- 1 1/2" MAXIMUM CLEARANCE FROM GRADE


- 2" FINISH OR AS DETERMINED BY CONSTRUCTION MANAGER DURING BID WALK
- 4" COMPACTED 95% BASE MATERIAL OR AS DETERMINED BY CONSTRUCTION MANAGER DURING BID WALK.
- (14) FINISH GRADE SHALL BE UNIFORM AND LEVEL
- GATE POST 4" SCHEDULE 40 PIPE. FOR GATE WIDTHS UP THRU 7 FEET OR 4 FEET FOR DOUBLE SWING GATE, PER ASTM-F1083
- (16) GATE FRAME: 1 1/2" PIPE, PER ASTM-F1083
- (17) GATE FRAME: 1 5/8" PIPE, PER ASTM-F1083
- (18) GATE DIAGONAL GALVANIZED STEEL 1 1/2" PIPE
- 19 DUCK BILL OPEN GATE HOLDER. VERIFY LOCATION IN FIELD PRIOR TO INSTALLATION
- 20 GEOTEXTILE FABRIC
- (21) LINE POST: CONCRETE FOUNDATION (2000 PSI)
- (22) CORNER POST: CONCRETE FOUNDATION (2000 PSI)
- (23) GATE POST" CONCRETE FOUNDATION (2000 PSI)
- (24) STYMIE LOCK OR EQUIVALENT


LANDSCAPE NOTES

- 1. ALL PLANTS MUST BE HEALTHY, VIGOROUS MATERIAL, FREE OF PESTS AND DISEASE.
- 2. ALL PLANTS MUST BE CONTAINER-GROWN OR BALLED AND BURLAPPED AS SPECIFIED.
- 3. ALL TREES MUST BE STRAIGHT TRUNKED, FULL HEADED AND MEET ALL REQUIREMENTS SPECIFIED.
- ALL PLANTS ARE SUBJECT TO THE APPROVAL OF THE ENGINEER'S REPRESENTATIVE BEFORE, DURING, AND AFTER INSTALLATION.
- 5. ALL TREES MUST BE GUYED OR STAKED AS SHOWN.
- 6. ALL PLANTS AND PLANTING AREAS MUST BE COMPLETELY MULCHED AS SPECIFIED
- PRIOR TO CONSTRUCTION, THE CONTRACTOR SHALL BE RESPONSIBLE FOR LOCATING ALL UNDERGROUND UTILITIES
 AND SHALL AVOID DAMAGE TO ALL UTILITIES DURING COURSE OF THE WORK. THE CONTRACTOR IS RESPONSIBLE
 FOR REPAIRING ALL DAMAGE TO UTILITIES, STRUCTURES, SITE APPURTENANCES, ETC. WHICH OCCURS AS A RESULT
 OF THE LANDSCAPE CONSTRUCTION.
- 8. THE CONTRACTOR IS RESPONSIBLE FOR FULLY MAINTAINING ALL PLANTING (INCLUDING, BUT NOT LIMITED TO: WATERING, SPRAYING, MULCHING, FERTILIZATION, ETC.) OF PLANTING AREAS UNTIL THE WORK IS ACCEPTED IN TOTAL BY THE ENGINEER'S REPRESENTATIVE.
- 9. THE CONTRACTOR SHALL COMPLETELY GUARANTEE ALL PLANT MATERIAL FOR A PERIOD OF ONE (1) YEAR BEGINNING AT THE DATE OF TOTAL ACCEPTANCE. THE CONTRACTOR SHALL PROMPTLY MAKE ALL REPLACEMENTS BEFORE OR AT THE END OF THE GUARANTEE PERIOD.
- 10. THE ENGINEER'S REPRESENTATIVE WILL APPROVE THE STAKED LOCATION OF ALL PLANT MATERIAL PRIOR TO INSTALLATION.
- 11. AFTER BEING DUG AT THE NURSERY SOURCE, ALL TREES IN LEAF SHALL BE ACCLIMATED FOR TWO (2) WEEKS UNDER A MIST SYSTEM PRIOR TO INSTALLATION.
- 12. ANY PLANT MATERIAL THAT DIES, TURNS BROWN OR DEFOLIATES (PRIOR TO TOTAL ACCEPTANCE OF THE WORK) SHALL BE PROMPTLY REMOVED FROM THE SITE AND REPLACED WITH MATERIAL OF THE SAME SPECIES, QUANTITY, SIZE AND MEETING ALL SPECIFICATIONS.
- 13. STANDARDS SET FORTH IN "AMERICAN STANDARD FOR NURSERY STOCK", LATEST EDITION, REPRESENT GUIDELINE SPECIFICATIONS ONLY AND SHALL CONSTITUTE MINIMUM QUALITY REQUIREMENTS FOR PLANT MATERIAL.



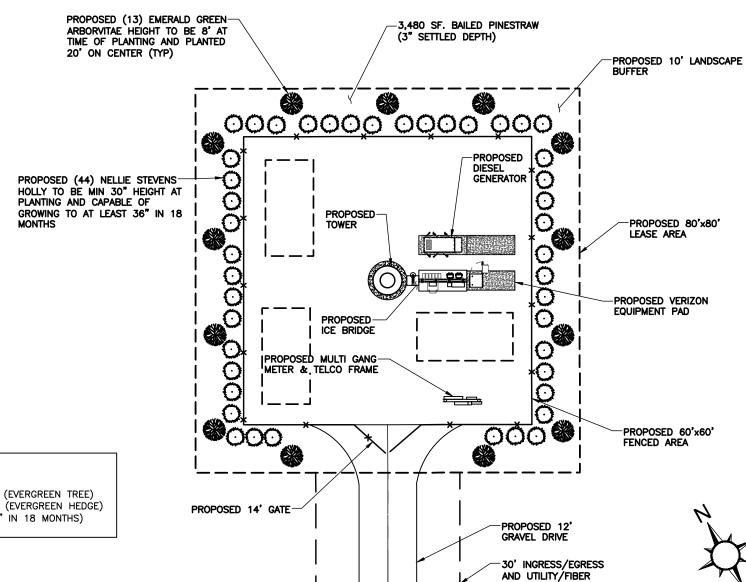

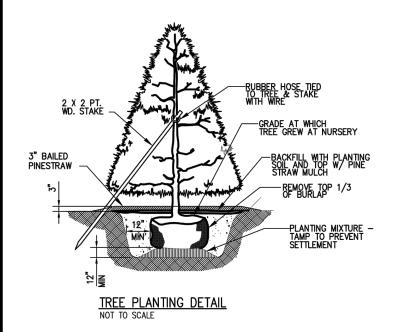

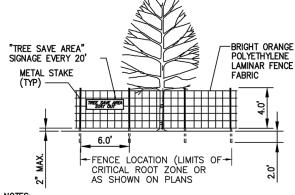


NOTES:

- 1) ALL PARKING WILL OCCUR ON EXISTING DRIVE.
 2) THERE WILL BE NO BURNING OR BURNAL OF
- ALL BUFFERS AND TREE SAVE AREAS ARE TO BE CLEARLY IDENTIFIED WITH FLAGGING AND/OR FENCING PRIOR TO COMMENCEMENT OF ANY LAND DISTURBANCE.

TREE PROTECTION DETAIL NOT TO SCALE




EASEMENT

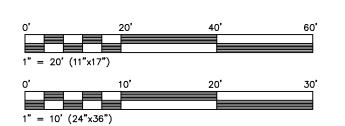



verizon /

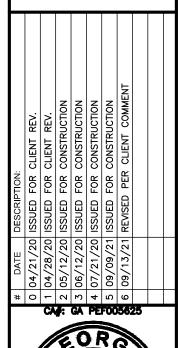

No. PE37206 **

09/13/2021

SITE NAME GA HWY52

SMW#: 20-0240 FUZE ID: 16093185

PSLC #: 500304

DESIGNED: JDS

DRAWN: MEH

CHECKED: BS

SHEET NAME

LANDSCAPE PLAN

SHEET NUMBER

GENERAL NOTES:

SCOPE: PROVIDE LABOR, EQUIPMENT, MATERIALS, ETC., REQUIRED TO COMPLETE THE INSTALLATION SHOWN

CODES AND STANDARDS:

INSTALLATION SHALL COMPLY WITH APPLICABLE LAWS AND ORDINANCES, UTILITY COMPANY REGULATIONS, & APPLICABLE REQUIREMENTS OF LATEST EDITIONS OF

PERMITS:

OBTAIN & PAY FOR REQUIRED PERMITS, LICENSES, FEES, INSPECTIONS, ETC.

COORDINATION:

COORDINATE ELECTRICAL WORK WITH OTHER TRADES.

SUBMIT BROCHURES FOR APPROVAL ON DISCONNECT SWITCH & OTHER MAJOR SYSTEM COMPONENTS.

6. FXISTING SERVICES:

DO NOT INTERRUPT EXISTING SERVICES WITHOUT WRITTEN PERMISSION OF THE

EQUIPMENT:

CONNECT ELECTRICALLY OPERATED EQUIPMENT.

8. RECORD DRAWINGS:

MAINTAIN A RECORD OF ALL CHANGES, SUBSTITUTIONS BETWEEN WORK AS SPECIFIED AND INSTALLED. RECORD CHANGES ON A CLEAN SET OF CONTRACT DOCUMENTS WHICH SHALL BE TURNED OVER TO THE OWNER UPON COMPLETION OF THE PROJECT.

9. IDENTIFICATION:

IDENTIFY DISCONNECT SWITCH WITH PERMANENT ENGRAVED NAMEPLATE.

10. GUARANTEE/WARRANTY:

GUARANTEE INSTALLATION TO BE FREE OF DEFECTS, SHORTS, GROUNDS. ETC., FOR A PERIOD OF ONE YEAR. FURNISH WARRANTY SO THE DEFECTIVE MATERIALS AND/OR WORKMANSHIP WILL BE REPAIRED/REPLACED IMMEDIATELY UPON NOTIFICATION AT NO COST TO THE OWNER FOR PERIOD OF WARRANTY.

11. CUTTING & PATCHING:

PROVIDE CUTTING REQUIRED TO DO THE WORK. DO NOT CUT STRUCTURAL ELEMENTS WITHOUT APPROVAL. PATCHING SHALL BE OF QUALITY EQUAL TO & OF MATCHING APPEARANCE OF EXISTING CONSTRUCTION.

12. TRENCHING & BACKFILL:

PROVIDE FOR ALL UNDERGROUND INSTALLED CONDUIT AND/OR CABLES.

UNDERGROUND CONDUIT SHALL BE SCHEDULE 40 PVC CONDUIT (MEETING NEMA TC2-1990). UNDERGROUND PVC CONDUIT SHALL TRANSITION TO RIGID GALVANIZED STEEL CONDUIT BEFORE RISING ABOVE GRADE OR WHEN SUBJECTED TO VEHICLE TRAFFIC LOADS. ALL CONDUIT BENDS SHALL BE A MINIMUM OF 24" RADIUS. EXPOSED CONDUIT SHALL BE RIGID GALVANIZED STEEL. RGS CONDUIT, WHEN SPECIFIED. SHALL MEET UL-6 FOR GALVANIZED STEEL. ALL FITTINGS SHALL BE SUITABLE FOR USE WITH THREADED RIGID CONDUIT. INTERIOR CONDUIT SHALL BE ELECTRICAL METALLIC TUBING WITH COMPRESSION TYPE FITTINGS.

14. SUPPORTS:

AS REQUIRED BY THE NEC.

15. CONDUCTORS:

USE 98% CONDUCTIVITY COPPER WITH TYPE THHN/THWN INSULATION, 600 VOLT, COLOR CODED. USE SOLID CONDUCTORS FOR WIRE UP TO #8 AWG. USE STRANDED CONDUCTORS FOR WIRE #8 AWG AND ABOVE.

16. CONNECTORS FOR POWER CONDUCTORS:

USE PRESSURE TYPE INSULATED TWIST CONNECTORS FOR #10 AWG AND SMALLER, USE SOLDERLESS MECHANICAL TERMINAL LUGS FOR #8 AWG AND

17. GROUNDING:

A. ALL MATERIALS SHALL BE INSTALLED PER MANUFACTURER'S RECOMMENDATIONS & INSTRUCTIONS.

B. ALL CONNECTIONS SHALL BE 2- HOLE LUG UNLESS UNDERGROUND. C. LUGS SHALL BE ATTACHED TO GROUND BARS USING STAINLESS STEEL OR HOT-DIPPED GALVANIZED STEEL BOLTS.

D. PROVIDE TESTING OF GROUNDING SYSTEM AS DIRECTED BY CONSTRUCTION MANAGER

GENERAL ELECTRICAL NOTES:

ALL ELECTRICAL WORK SHALL BE IN ACCORDANCE WITH THE LATEST VERSION OF THE NATIONAL ELECTRICAL CODE AND ALL LOCAL AND STATE CODES, LAWS, AND

2. ALL UNDERGROUND CONDUIT SHALL BE PVC SCHEDULE 40 UNLESS OTHERWISE INDICATED. CONDUITS EXPOSED ABOVE GROUND OR ROUTED UNDER GRAVEL ROAD SHALL BE RIGID GALVANIZED STEEL. ALL UNDERGROUND CONDUIT SHALL TRANSITION FROM PVC TO RIGID AT THE 90° BEND BELOW GRADE. SUPPLY UTILITY MARKING TAPE BURIED 12" BELOW GRADE ALONG ENTIRE LENGTH OF UNDERGROUND CONDUITS.

ALL CONDUCTORS SHALL BE COPPER WITH THHN/THWN INSULATION. CONTROL CONDUCTORS SHALL BE STRANDED. POWER & LIGHTING CONDUCTORS SHALL BE SOLID FOR #10 & #12 CONDUCTORS AND STRANDED FOR ALL OTHER SIZES.

ELECTRICAL DRAWINGS ARE IN PART DIAGRAMMATIC. COORDINATE ELECTRICAL WORK WITH BUILDING STRUCTURE AND MECHANICAL EQUIPMENT. PROVIDE ADDITIONAL SUPPORTS FOR ELECTRICAL EQUIPMENT WHERE THE BUILDING STRUCTURE IS NOT ADAPTED TO MOUNTING FQUIPMENT THEREON.

LOCATE ALL UNDERGROUND UTILITIES BEFORE TRENCHING. IF CONFLICTS ARISE, CONTACT UTILITY COMPANY AND ENGINEER IMMEDIATELY.

ALL EXPOSED CONDUITS SHALL HAVE WEATHERPROOF CAPS NOT DUCT TAPE.

PROVIDE 200 LB TEST PULL WIRES IN EACH EMPTY TELEPHONE AND POWER

COORDINATE ALL CONDUIT STUB-UP LOCATIONS WITH UTILITY COMPANY.

PROVIDE WEATHERPROOF SEALS FOR ALL CONDUIT STUB-UPS.

10. CONDUIT TO BE INSTALLED PER NEC REQUIREMENTS. MAX OF 4 90'S ALLOWED IN SINGLE RUN OF CONDUIT. IF MORE BENDS ARE REQUIRED INSTALL PULL BOX EVERY (4) 90'S. 4 BENDS OR 150' IN LENGTH

11. FIBER CONDUITS: CONDUITS TO BE INSTALLED FROM ROW OF PUBLIC ROAD TO COMPOUND. HAND HOLES TO BE INSTALLED IN ROW, AT COMPOUND AND EVERY 400' BETWEEN (OR AS DIRECTED BY UTILITY OR REQUIRED BY NEC). USE HIGHLINE PHA173030 12,000LB HAND HOLE OR APPROVED EQUIVALENT. *CONSULT CM FOR CORRECT FIBER PROVIDER OPTION.

*CONTRACTOR RESPONSIBLE FOR ENSURING EASEMENT IS CORRECTLY MARKED IN FIELD BEFORE INSTALLING FIBER.

GENERAL GROUNDING NOTES:

1. TO ENSURE PROPER BONDING, ALL CONNECTIONS SHALL BE AS FOLLOWS:

#2 TINNED SOLID COPPER WIRE: CADWELDED TO RODS OR GROUND RING LUGS AND BUS BAR (UNLESS NOTED OTHERWISE): SANDED CLEAN, COATED WITH OXIDE INHIBITOR AND BOLTED FOR MAXIMUM SURFACE CONTACT. ALL LUGS SHALL BE COPPER (NO ALUMINUM SHALL BE PERMITTED). PROVIDE LOCK WASHERS FOR ALL MECHANICAL CONNECTIONS FOR GROUND CONDUCTORS. USE STAINLESS STEEL HARDWARE THROUGHOUT.

2. ALL GROUNDING CABLE IN CONCRETE OR THROUGH WALLS SHALL BE IN 3/4" PVC CONDUIT. SEAL AROUND CONDUIT THROUGH WALLS. NO METALLIC CONDUIT SHALL BE LISED FOR GROUNDING CONDUCTORS

3. GROUND RODS SHOULD BE SPACED 2X HEIGHT APART AROUND COMPOUND GROUND RING. (EX. 10' ROD SHOULD BE SPACED 20' APART).

4. VERIZON'S CONSTRUCTION PROJECT MANAGER OR VERIZON'S REPRESENTATIVE WILL BE PRESENT TO INSPECT CADWELDS AND MEGGER TEST DURING BURIAL. MAXIMUM 5 OHMS RESISTANCE IS REQUIRED. IF COMPOUND GROUND RING AND RODS DON'T MEET REQUIREMENTS THEN CONTINUE GROUND RING DOWN EASEMENT WITH GROUND RODS SPACED AT 2X HEIGHT APART.

5. DO NOT INSTALL GROUND RING OUTSIDE OF LEASED AREA.

MAKE ALL GROUND CONNECTIONS AS SHORT AND DIRECT AS POSSIBLE. AVOID SHARP BENDS. ALL BENDS SHALL BE A MINIMUM 8" RADIUS AND NO GREATER THAN 90 DEGREES.

7. ALL CADWELDS TO BURIED GROUND RING SHALL BE THE PARALLEL TYPE, EXCEPT FOR THE GROUND RODS WHICH SHALL BE THE TEE TYPE.

8. BOND DOOR FRAMES, HANDRAILS, UNUSED HATCH PLATES AND MISCELLANEOUS LIFTING EYE/PLATES TO GROUND RING. BOND METAL AWNING TO DOOR FRAME.

 ALL GROUNDING TO ABOVE GRADE RIGID CONDUITS TO BE ATTACHED USING A COLD WATER GROUND CLAMP, DO NOT EXOTHERMICALLY WELD TO CONDUITS. 10. ALL BUS BAR SHALL BE GALVANIZED. ALL CONNECTIONS TO BUS BAR ARE TO BE

11. ALL GROUNDING IS TO COMPLY WITH VERIZON NSTD46. IF YOU DO NOT HAVE A COPY OF THE PRACTICE/STANDARD PLEASE REQUEST A COPY FROM THE PROJECT





CA#: GA PEF005625



SITE NAME GA HWY52

SMW#: 20-0240


FUZE ID: 16093185 PSLC #: 500304

DESIGNED: JDS DRAWN: MFH CHECKED: BS

SHEET NAME

ELECTRICAL NOTES

SHEET NUMBER

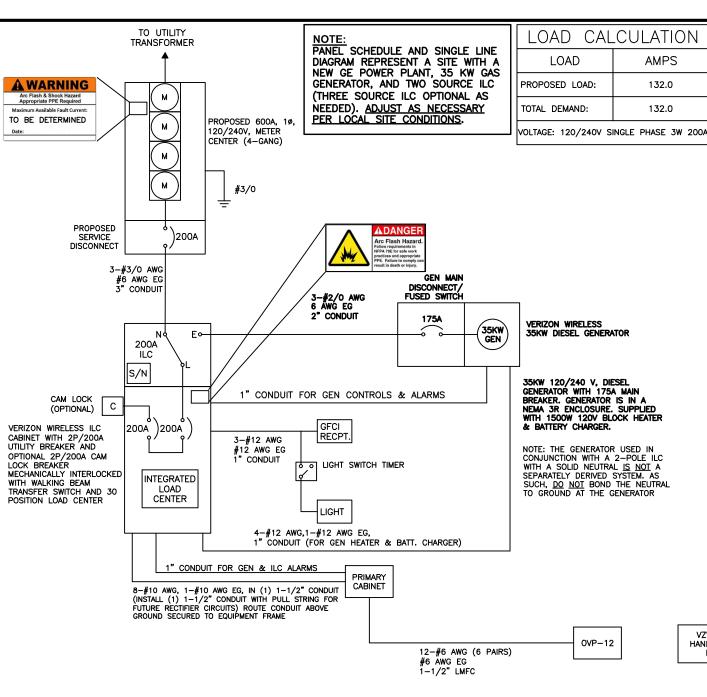


ELECTRICAL SINGLE LINE DIAGRAM

- NOTES:
 1. ALL EQUIPMENT SHALL BE NEMA 3R RATED.
- ALL EQUIPMENT SHALL BE LIGHTNING PROTECTED IN ACCORDANCE WITH TIA-222-G AND VERIZON WIRELESS
- 3. CONDUCTOR SIZES AND DISTANCES HAVE BEEN SIZED FOR 3% MAX VOLTAGE DROP (TOTAL SYSTEM VOLTAGE
- DROP ON BOTH FEEDERS AND BRANCH CIRCUITS TO THE FARTHEST DEMAND SHALL NOT EXCEED 5%). WIRE SIZING AND MAXIMUM DISTANCE FROM GENERATOR TO ILC ASSUMES POWER FACTOR OF 0.9. BELOW GRADE CONDUIT SHALL BE SCHEDULE 80 PVC. ABOVE GRADE CONDUIT SHALL BE GALVANIZED RIGID CONDUIT. BELOW GRADE PVC CONDUIT SHALL TRANSITION TO GRC PRIOR TO RISING ABOVE GRADE. ALL BENDS SHALL HAVE A MINIMUM 24" RADIUS. ALL FITTINGS SHALL BE SUITABLE FOR USE WITH THREADED RIGID CONDUIT. VERIFY CONDUIT TYPE WITH LOCAL CONSTRUCTION MANAGER AND ADJUST IF NECESSARY, ALL CONDUIT SHALL MEET NEC, STATE, AND LOCAL CODE REQUIREMENTS AS REQUIRED.

PANI NAM	E:	VZW	ILC		MODEL NUMBE	R:	AS	co	D300L	SERIES					
RATE VOL	D ΓAGE:	240	120	VOLTS	PHASE,	/WIRE:	1	3							
MAIN		200	AMPS		BUS RATING:	•	20	00			KEY DOOR LATCH:	YES			
MOU		SURF	ACE		NEUTRA BAR:		YI	ES			HINGED DOOR:	YES	1		
ENCI	LOSURE	NEMA	3R		AIC:		6	5K							
	LICAGE	BUS	AMPS									BUS	AMPS	USAGE	
POS	FACTOR	L1	L2	LOAD	POLES	AMPS	L1	L2	AMPS	POLES	LOAD	L1	L2	FACTOR	POS
1		18							_		FUTURE	18			2
3			18	RECTIFIER	2	30A			2	30A	RECTIFIER		18		4
5		18									FUTURE	18			6
7			18	RECTIFIER	2	30A			2	30A	RECTIFIER		18		8
9		18													10
11			18	RECTIFIER	2	30A									12
13		18													14
15			18	RECTIFIER	2	30A									16
17		16		GFI RECEPT. /LIGHT	1	20A									18
19			16	BLOCK HEATER	1	20A									20
21		16		BATT. CHARGER	1	20A									22
23															24
25															26
27															28
29															30
	1	104	88	:SUB TOTAL AMPS		<u> </u>					SUB TOTAL AMPS:	36	36		1
				1							FACTORED TOTAL AMPS:	140	124		

- ALL CONDUCTORS ARE TYPE THWN (75°C) COPPER.
 MAXIMUM LENGTH OF RUN FOR RECTIFIER CIRCUITS IS 50FT.
- ASCO INTEGRATED LOAD CENTER INCLUDES 200 AMP MAIN DISCONNECT
- AND TRANSFER SWITCH FOR PORTABLE OR PERMANENT GENERATOR. RECTIFIER LOADS ARE CONSIDERED TO BE NON-CONTINUOUS

PANEL SCHEDULE

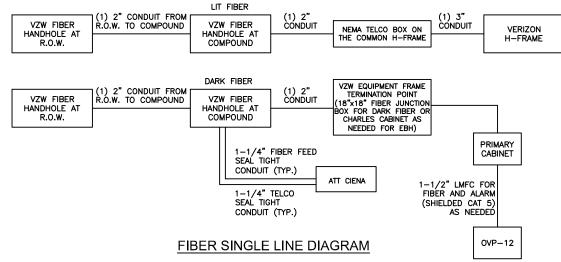

- * ADD (1) ADDITIONAL 2" CONDUIT FOR DARK FIBER (2 TOTAL) IF REQUIRÉD BY LOCAL MARKET FACILITIES, VERIFY PRIÒR TO CONSTRUCTION. (ADD 2 PULL STRINGS TO EACH CONDUIT)
- ** VERIFY EBH REQUIREMENTS WITH TELCO PROVIDER PRIOR TO CONSTRUCTION. (ADD 2 PULL STRINGS TO EACH CONDUIT)





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09/13/2021

SITE NAME GA HWY52

SMW#: 20-0240 FUZE ID: 16093185

PSLC #: 500304

DESIGNED: JDS DRAWN: MEH CHECKED: BS

SHEET NAME

ONE-LINE DIAGRAMS & PANEL SCHEDULE

SHEET NUMBER

E-2

CONSULT WITH CM FOR FIBER PROVIDER REQUIREMENTS PRIOR TO CONSTRUCTION

REFER TO E-1 FOR GENERAL ELECTRICAL NOTES


-EQUIPMENT

H-FRAME


UTILITY SCHEDULE:

- 1. CONTRACTOR TO INSTALL (2) 3"C WITH PULL STRING FOR POWER SERVICE FROM NEW TRANSFORMER TO NEW MULTI-TENANT METER CENTER. (SEE PM/CM FOR DETAILS ON METER CENTER.) VERIFY WITH UTILITY PROVIDER FOR CONDUIT SIZE, STUB UP LOCATION, OR WEATHER HEAD LOCATION REQUIREMENTS. (REFER TO N.E.C. AND LOCAL CODES FOR BURIAL REQUIREMENTS. SEE DETAIL 6, SHEET E-5 FOR TRENCH EXAMPLE.)
- 2. PROVIDE (1) 75'± 3"C FOR POWER SERVICE FROM MULTI TENANT METER CENTER TO 200A, 120/240V, 1ø INTEGRATED LOAD CENTER (ILC).
- 3. PROVIDE (1) 75'± 2"C W PULL STRING AND INNERDUCT FROM PRIMARY TELCO BOX MOUNTED ON PRIMARY UTILITY H-FRAME TO VERIZON TELCO BOX ON VERIZON EQUIPMENT H-FRAME. (SEE C-4 FOR H-FRAME DETAIL.).
- 4. PROVIDE (2) 1-1/2" CONDUITS FOR POWER FROM INTEGRATED LOAD CENTÉR TO PRIMARY CABINET.
- 5. NOT USED
- 6. PROVIDE (1) 1-1/2" CONDUIT FOR POWER FROM INTEGRATED LOAD CENTER TO GENERATOR DISCONNECT & (1) 1" CONDUIT FOR ALARMS & GENERATOR CONTROLS.
- NOT USED
- 8. PROVIDE (1) 1" CONDUIT FOR POWER FROM LOAD CENTER TO GENERATOR FOR BATTERY CHARGER & BLOCK HEATER.
- 9. PROVIDE (1) 2" CONDUIT FROM VERIZON TELCO BOX TO PRIMARY CABINET FOR FIBER.
- 10. NOT USED.
- 11. NOT USED.
- 12. NOT USED.
- 13. PROVIDE (2) 185'± 2" CONDUITS WITH MULE TAPE FOR TELEPHONE SERVICE. SEE E-3.1 FOR ROUTE, HANDHOLE, AND PULL BOX LOCATIONS. PULL BOX SPACING SHALL BE NO GREATER THAN 300'.
- 14. PROVIDE (1) 1" CONDUIT FOR POWER FROM INTEGRATED LOAD CENTER TO LIGHTS, TIMER AND CONVENIENCE OUTLET.
- 15. NOT USED

- SCHEDULE NOTES:
 1. SEE SHEET E-2 FOR WIRING REQUIREMENTS. ALL CONDUITS INSTALLED WITH PULL STRING
- UNLESS OTHERWISE NOTED.
- MAINTAIN ALL CLEARANCES AS REQUIRED BY

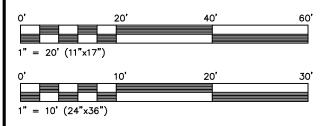



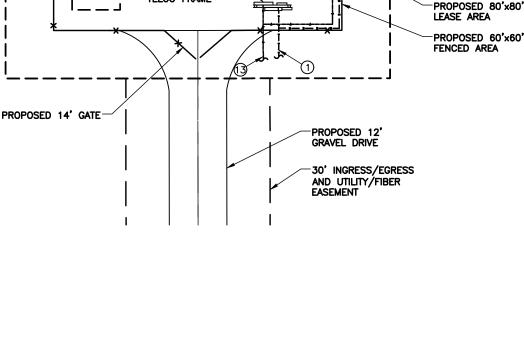

PROPOSED-

PROPOSED-

ICE BRIDGE


PROPOSED MULTI-GANG METER &

TELCO FRAME

PROPOSED DIESEL

GENERATOR

-PROPOSED VERIZON EQUIPMENT PAD

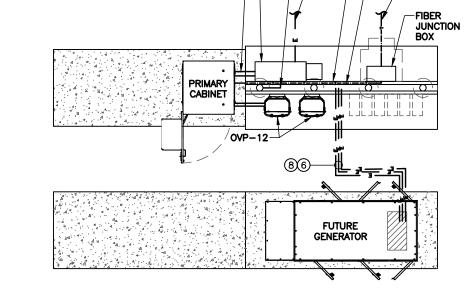

INTEGRATED-

LOAD CENTER

4

(1)(2)

TYPICAL ELECTRICAL SCENARIO NOT TO SCALE



verizon^v

CA#: GA PEF005625		DATE 04/21/20 04/28/20 05/12/20 05/12/20 06/12/20 07/21/20 09/09/21	# DATE DESCRIPTION: 0 04/21/20 ISSUED FOR CLIENT REV. 1 04/28/20 ISSUED FOR CLIENT REV. 2 05/12/20 ISSUED FOR CONSTRUCTION 3 06/12/20 ISSUED FOR CONSTRUCTION 4 07/21/20 ISSUED FOR CONSTRUCTION 5 09/09/21 ISSUED FOR CONSTRUCTION 6 09/13/21 REVISED PER CLIENT COMMENT
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09/13/2021

SITE NAME GA HWY52

SMW#: 20-0240

FUZE ID: 16093185 PSLC #: 500304

DESIGNED: JDS DRAWN: MFH CHECKED: BS

SHEET NAME

UTILITY SITE PLAN


SHEET NUMBER



UTILITY COORDINATION NOTES AS OF 05/27/20:
- ENTIRE POWER COMPANY ROUTE IS BURIED AND WILL COST THE CUSTOMER

- THAT INCLUDES 1700' BURIED AND A ROAD BORING WITH A \$1500 SERVICE AND TRANSFER FEE.
- CONTRACTOR TO SET TWO 3" CONDUIT FROM ROW TO NEW METER RACK.
- 2 TO 3 WEEKS AFTER ACCOUNT SETUP.

CONSULT WITH CM FOR FIBER PROVIDER REQUIREMENTS PRIOR TO CONSTRUCTION

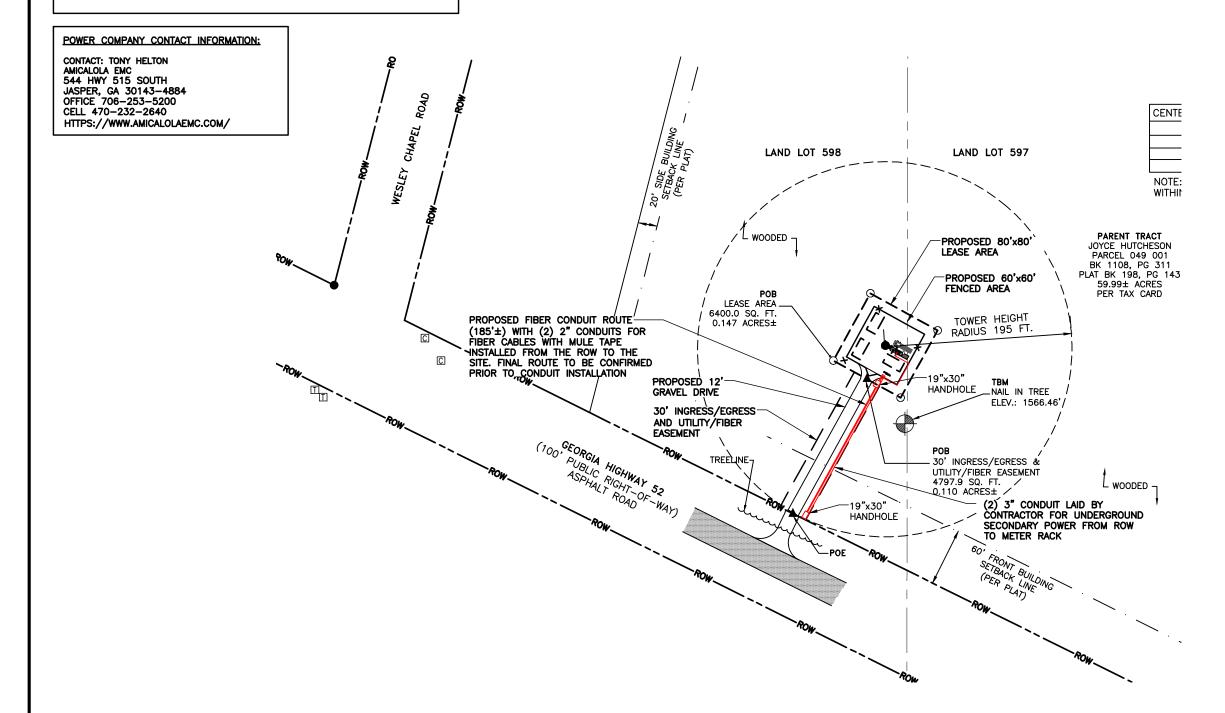

UTILITY ROUTING PLAN



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DATE DESCRIPTION:	0 04/21/20 ISSUED FOR CLIENT REV.	1 04/28/20 ISSUED FOR CLIENT REV.	2 05/12/20 ISSUED FOR CONSTRUCTION	3 06/12/20 ISSUED FOR CONSTRUCTION	4 07/21/20 ISSUED FOR CONSTRUCTION	5 09/09/21 ISSUED FOR CONSTRUCTION	6 09/13/21 REVISED PER CLIENT COMMENT		
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CA#: GA PEF005625



SITE NAME GA HWY52

SMW#: 20-0240


FUZE ID: 16093185 PSLC #: 500304


DESIGNED: JDS DRAWN: MEH CHECKED: BS

SHEET NAME

UTILITY SITE PLAN

E-3.1

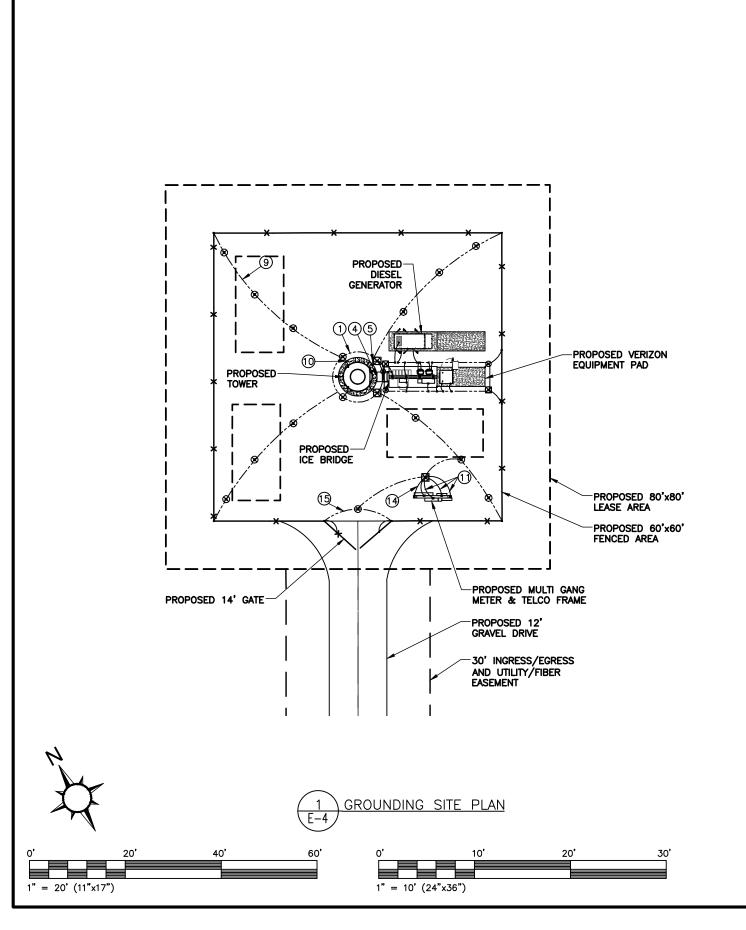


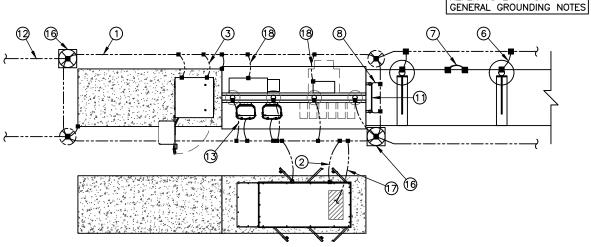



GROUNDING SCHEDULE:

- 1. PROVIDE #2 COPPER GROUND RING BURIED AT MINIMUM 30" BELOW GRADE.
- 2. BOND GENERATOR TO GROUND RING IN 2 PLACES.
- 3. BOND EACH CABINET TO GROUND RING IN 2 PLACES.
- 4. BOND CABLE GROUND KIT TO TOWER GROUND BAR.
- 5. BOND TOWER GROUND BAR TO GROUND RING.
- 6. BOND EVERY ICE BRIDGE POST TO GRIP STRUT. (TYP.)
- 7. CONNECT ICE BRIDGE SECTIONS WITH JUMPERS. (TYP.)
- 8. BOND CABLE GROUND KIT TO EQUIPMENT GROUND BAR AND GROUND RING.
- 9. BOND TOWER GROUND RING TO COMPOUND GROUND RING (TYP.)
- 10. BOND TOWER TO TOWER GROUND RING TYPICAL AT EACH LEG. (3 PLACES)
- 11. CABINET GROUND BAR
- 12. BOND ALL FENCE POST WITHIN 6' OF GROUND RING TO GROUND RING.
- 13. BOND EQUIPMENT H-FRAME POST TO GROUND RING. (TYP.)
- 14. GROUND BUS BAR ON NEW METER TO GROUND ROD.
- 15. BOND EACH FENCE/GATE POST TO GROUND RING.
- 16. INSPECTION SLEEVE, SEE DETAIL 1 ON SHEET E-5
- 17. BOND GENERATOR FRAME TO GROUND RING
- 18. BOND ALL EQUIPMENT CABINETS TO GROUND RING
- 19. NOT USED

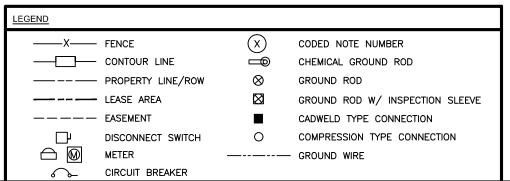



REFER TO E-1 FOR



## DATE 0 04/21/2 1 04/28/2 2 05/12/2 3 06/12/2 4 07/21/2 5 09/09/2 6 09/13/2	DESCRIPTION:	0 04/21/20 ISSUED FOR CLIENT REV.	1 04/28/20 ISSUED FOR CLIENT REV.	2 05/12/20 ISSUED FOR CONSTRUCTION	3 06/12/20 ISSUED FOR CONSTRUCTION	4 07/21/20 ISSUED FOR CONSTRUCTION	5 09/09/21 ISSUED FOR CONSTRUCTION	6 09/13/21 REVISED PER CLIENT COMMENT		
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SITE NAME
GA HWY52

SMW#: 20-0240

FUZE ID: 16093185 PSLC #: 500304


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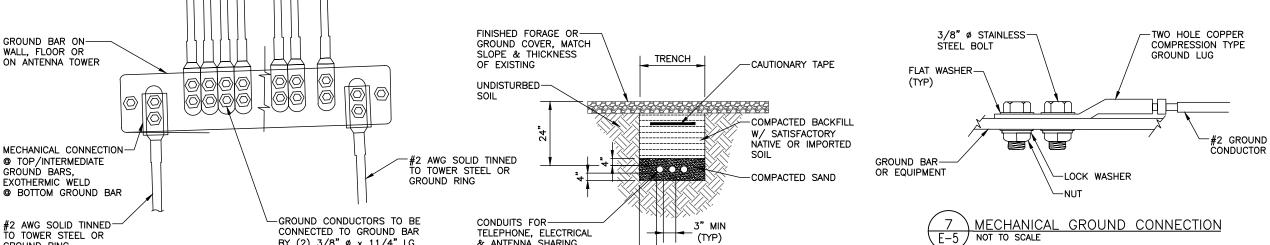
SHEET NAME

GROUNDING SITE PLAN

SHEET NUMBER

E-4



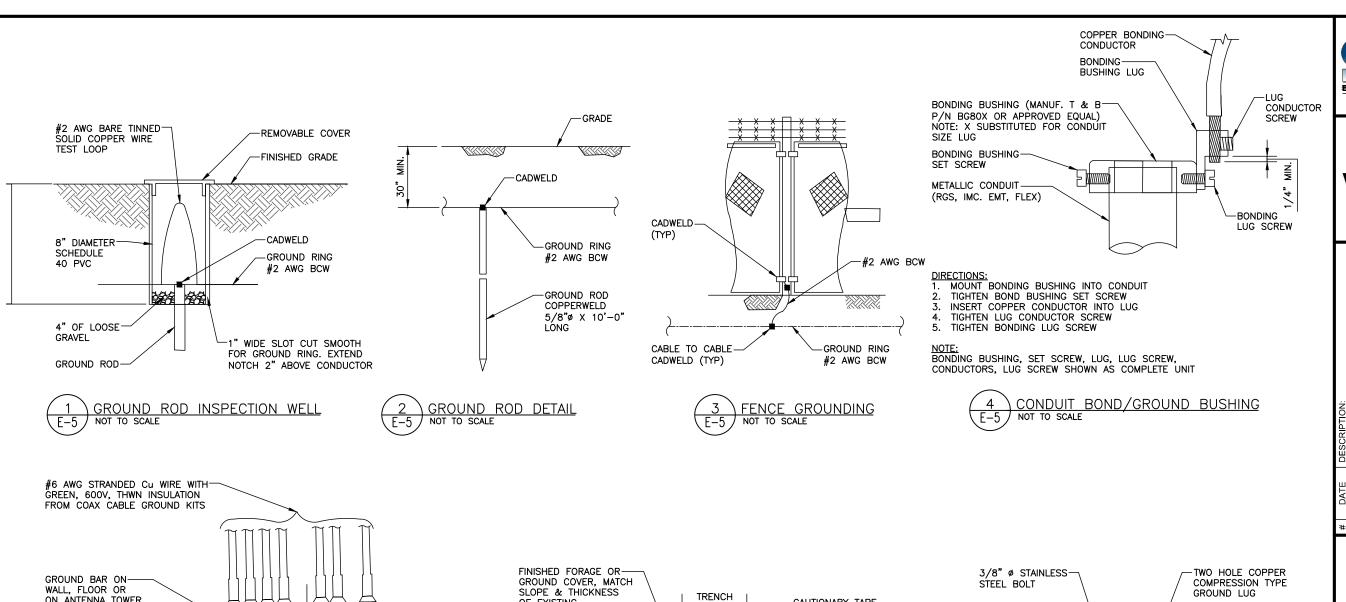

NOTES:

GROUND RING

NOT TO SCALE

- GALVANIZED STEEL GROUND BAR 1/4"x4"x14" 2-HOLE
 CONNECTORS TO MATCH NEMA DOUBLE LUG CONFIGURATION
 SIMILAR INSTALLATION FOR TOP AND BOTTOM TOWER GROUND BARS AND FOR COAX ENTRY PORT GROUND BARS
- 3. VZW STOLEN PROPERTY TO BE ENGRAVED IN STEEL

* CONDUIT SIZE, TYPE, QUANTITY AND SEPARATION DIMENSIONS TO BE VERIFIED WITH LOCAL UTILITY COMPANY REQUIREMENTS

6" MIN

TYP)

INSTALLATION OF GRD WIRE TO COAX CABLE GRD BASE

& ANTENNA SHARING

WHERE APPLICABLE

BY (2) 3/8" ø x 11/4" LG

BOLTS, SÉE DETAIL THIS PAGE

DIRECT BURIED CONDUIT NOT TO SCALE



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09/13/2021 SITE NAME

GA HWY52

SMW#: 20-0240 FUZE ID: 16093185


PSLC #: 500304

DESIGNED: JDS DRAWN: MFH CHECKED: BS

SHEET NAME

GROUNDING DETAILS

SHEET NUMBER

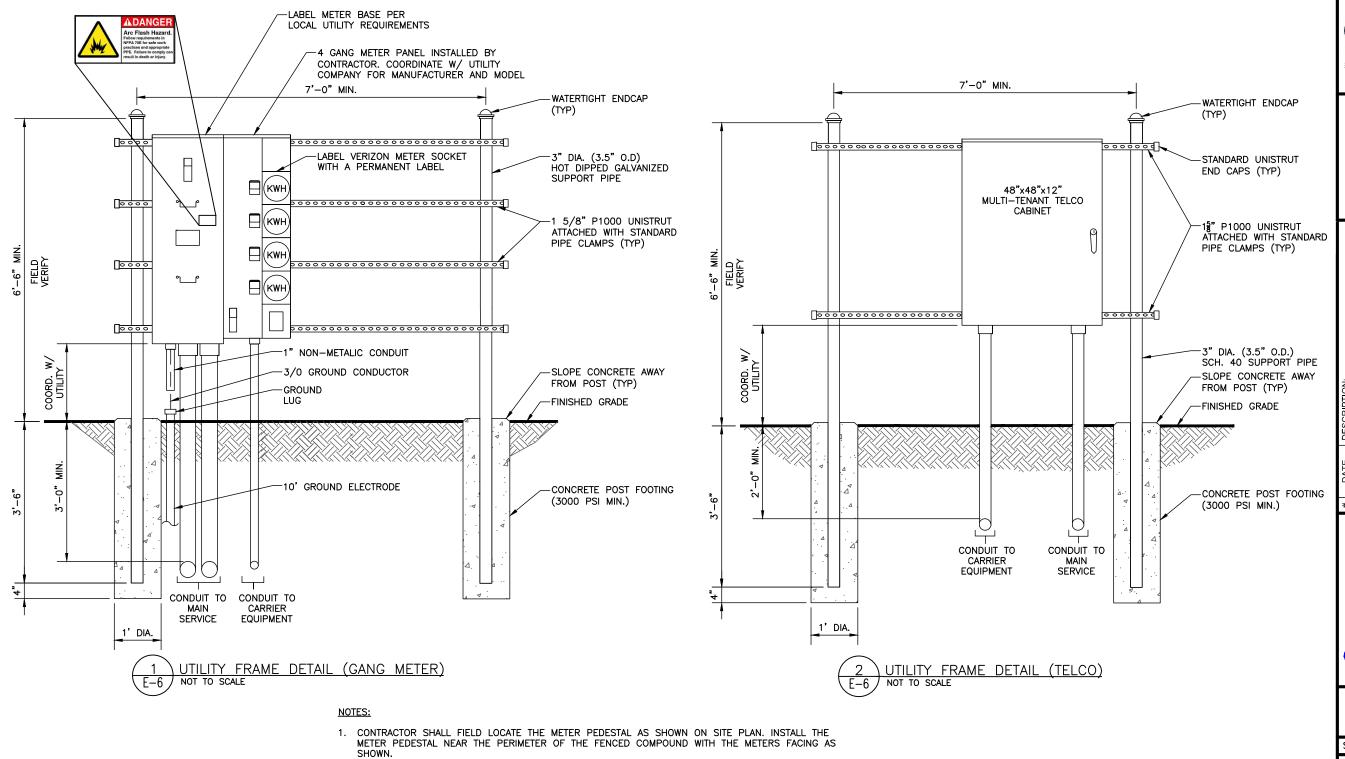

- 2. THE CONTRACTOR SHALL COORDINATE WITH THE LOCAL UTILITY COMPANY FOR THE CONDUIT RUN TO THE MAIN SERVICE CONNECTION OR TRANSFORMER.
- 3. THE CONTRACTOR SHALL COORDINATE WITH THE LOCAL UTILITY COMPANY FOR GROUND ROD REQUIREMENTS. IF REQUIRED, THE CONTRACTOR SHALL ORDER AND PAY FOR NECESSARY GROUND TESTS.
- 4. SUPPORT POST AND UNISTRUT SHALL BE GALVANIZED. PIPE CLAMPS AND HARDWARE SHALL BE GALVANIZED OR STAINLESS STEEL.
- 5. TELCO CABINET SHALL BE 48"x48"x12" HOFFMAN OR EQUIVALENT. PROVIDE ₹" PLYWOOD BACKBOARD INSIDE THE MULTI-TENANT TELCO CABINET.
- 6. ADJUSTMENTS TO THE METER PEDESTAL DESIGN MAY BE REQUIRED DEPENDING ON THE EXACT METER PANEL INSTALLED. CONTRACTOR SHALL FIELD COORDINATE ADJUSTMENTS AND INFORM THE ENGINEER IF ANY UNUSUAL CONDITIONS ARE FOUND TO EXIST.



verizon /

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No. PE37206 X

GA_HWY52

SITE NAME

SMW#: 20-0240 FUZE ID: 16093185

PSLC #: 500304

DESIGNED: JDS
DRAWN: MEH
CHECKED: BS

SHEET NAME

PRIMARY UTILITY FRAME DETAILS

SHEET NUMBER

E-6

EXHIBIT 4

*********** Federal Airways & Airspace Summary Report: New Construction Antenna Structure *********** Airspace User: Shennay Hampton File: NORTH GEORGIA GA HWY52 Location: Dawsonville, GA Latitude: 34°-32'-05.51" Longitude: 84°-11'-25.64" SITE ELEVATION AMSL.....1570 ft. STRUCTURE HEIGHT.....195 ft. OVERALL HEIGHT AMSL.....1765 ft. NOTICE CRITERIA FAR 77.9(a): NNR (DNE 200 ft AGL) FAR 77.9(b): NNR (DNE Notice Slope) FAR 77.9(c): NNR (Not a Traverse Way) FAR 77.9: NNR FAR 77.9 IFR Straight-In Notice Criteria for 5GA FAR 77.9: NNR FAR 77.9 IFR Straight-In Notice Criteria for 9A0 FAR 77.9(d): NNR (Off Airport Construction) NR = Notice Required NNR = Notice Not Required PNR = Possible Notice Required (depends upon actual IFR procedure) For new construction review Air Navigation Facilities at bottom of this report. Notice to the FAA is not required at the analyzed location and height for slope, height or Straight-In procedures. Please review the 'Air Navigation' section for notice requirements for offset IFR procedures and EMI.

OBSTRUCTION STANDARDS FAR 77.17(a)(1): DNE 499 ft AGL

```
FAR 77.17(a)(2): DNE - Airport Surface
       FAR 77.19(a): DNE - Arrivort Surface
FAR 77.19(b): DNE - Horizontal Surface
FAR 77.19(b): DNE - Conical Surface
FAR 77.19(c): DNE - Primary Surface
FAR 77.19(d): DNE - Approach Surface
FAR 77.19(e): DNE - Approach Transitional Surface
FAR 77.19(e): DNE - Abeam Transitional Surface
      VFR TRAFFIC PATTERN AIRSPACE FOR: 5GA: ELLIOTT FIELD
      Type: A RD: 25903.5 RE: 1480
        FAR 77.17(a)(1): DNE

FAR 77.17(a)(2): DNE - Height No Greater Than 200
feet AGL.
        VFR Horizontal Surface: DNE
                                   DNE
        VFR Conical Surface:
        VFR Primary Surface:
                                     DNE
        VFR Approach Surface: DNE
        VFR Transitional Surface: DNE
      VFR TRAFFIC PATTERN AIRSPACE FOR: 9A0: LUMPKIN COUNTY-WIMPYS
      Type: A RD: 53992.4 RE: 1311
        FAR 77.17(a)(1): DNE FAR 77.17(a)(2): Does Not Apply.
        VFR Horizontal Surface: DNE
        VFR Conical Surface: DNE
VFR Primary Surface: DNE
VFR Approach Surface: DNE
        VFR Transitional Surface: DNE
      TERPS DEPARTURE PROCEDURE (FAA Order 8260.3, Volume 4)
        FAR 77.17(a)(3) Departure Surface Criteria (40:1)
        DNE Departure Surface
     MINIMUM OBSTACLE CLEARANCE ALTITUDE (MOCA)
        FAR 77.17(a)(4) MOCA Altitude Enroute Criteria
        The Maximum Height Permitted is 4000 ft AMSL
      PRIVATE LANDING FACILITIES
        No Private Landing Facilites Are Within 6 NM
     AIR NAVIGATION ELECTRONIC FACILITIES
                    ST
                                                 DIST DELTA
GRND APCH
       IDNT
                TYPE AT FREQ VECTOR (ft) ELEVA ST LOCATION
ANGLE BEAR
      HRS VORTAC R 109.8 28.99 169944 -1895 GA
                       -.64
HARRIS
      BUF RADAR Y 2735.0 152.67 183536 +497 GA
BUFORD
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CFR Title 47, \$1.30000-\$1.30004

AM STUDY NOT REQUIRED: Structure is not near a FCC licensed AM station.

Movement Method Proof as specified in \$73.151(c) is not required.

Please review 'AM Station Report' for details.

No AM Stations were located within 3.0 km.

Airspace® Summary Version 20.3.559

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05-13-2020 15:05:25



10300 Old Alabama Connector Road Alpharetta, GA 30022-1117

September 2, 2021

Dawson County Harmony Gee, Zoning Administrator 25 Justice Way, Suite 2322 Dawsonville, GA 30534

Re: Application for Conditional Use Permit, Parcel ID 049-001, located at the Intersection of Wesley Chapel Rd & GA Hwy 52, Dawsonville, GA

Dear Sir/Madam,

The proposed 195-foot telecommunications facility proposed to be located close the intersection of Wesley Chapel Road and GA Hwy 52, Dawsonville, GA is strategically located to enable Verizon Wireless to provide reliable voice and broadband data coverage to this surrounding area of northeast Dawson County. As indicated on the accompanying exhibits, the proposed facility will greatly improve wireless service coverage along Hwy 52 and agribusiness area north and south side of Hwy 52.

The proposed tower height is the minimum height needed to properly provide improved rural coverage and accommodate anticipated future growth for wireless demand in this area. The proposed facility will allow Verizon Wireless to mount cellular antennas at a height of 185 feet above ground level (1578 feet above mean sea level), which is critical to achieve quality coverage and indoor-level service quality in this portion of rural Dawson County. The location of this additional coverage site will also enable Verizon Wireless to provide additional calling and data resources that might be needed in the event of an emergency.

Verizon Wireless made every attempt to utilize any existing structures to meet the network design goals. There are no known, registered antenna structures within 1.0 mile of any edge of the search area. There were also no known, registered antenna structures within 2.0 miles of the search area radius.

Verizon Wireless provides Commercial Mobile Radio Services ("CMRS") under licenses granted by the Federal Communications Commission ("FCC"). Pursuant to these licenses, Verizon Wireless is authorized to provide CMRS and operate a CMRS network in many geographic areas throughout the nation, including Dawson County, GA. The FCC exclusively regulates all technical aspects of Verizon Wireless' operations and network and preempts all state and local regulation of radiofrequency transmissions. The FCC rules protect co-channel and adjacent licensees against harmful interference. The proposed facility will be designed and built-in compliance with all applicable FCC

requirements. The following points cover Verizon Wireless' practices pertinent to complying with the FCC requirements:

- 1. Verizon Wireless locates its transmitting antenna(s) in order to maximize vertical and horizontal separation from other operator's systems to minimize interference potential.
- 2. All operating hardware at the site is type-accepted by the FCC as far as emission levels within our licensed frequency band in addition to spurious emissions outside of our frequency band.
- 3. The power levels generated by the base station hardware and corresponding effective radiated power (ERP) from the transmit antenna(s) are within the limitations specified by Part 22 (for cellular), Part 24 (for PCS), or Part 101 (for microwave) of the Commission's Rules.
- 4. Intermodulation studies are prepared and analyzed considering all other wireless carriers on our tower to ensure no mixing of frequencies will create harmful interference to or from our wireless system.

The FCC has established safety rules relating to potential RF exposure from cell sites. The rules are codified at 47 C.F.R § 1.1310. The FCC provides guidance on how to ensure compliance with its rules in the FCC Office of Engineering and Technology Bulletin 65, available at: https://transition.fcc.gov/Bureaus/Engineering Technology/Documents/bulletins/oet65/oet65.pdf

The FCC developed the RF standards, known as Maximum Permissible Exposure (MPE) limits, in consultation with numerous other federal agencies, including the Environmental Protection Agency, the Food and Drug Administration, and the Occupational Safety and Health Administration. The FCC provides information about the safety of radio frequency (RF) emissions from cell towers on its website at: https://www.fcc.gov/engineering-technology/electromagnetic-compatibility-division/radio-frequency-safety/faq/rf-safety.

Please refer to the FCC Office of Engineering and Technology Bulletin 65 and the attached Verizon Wireless RF Brochure for information on RF exposure guidelines, RF safety, and landlord responsibilities.

For the above-mentioned reasons, the Verizon Wireless Network Team respectfully requests approval of the Special Use permit application to allow the proposed 195-foot telecommunications facility, which will allow Verizon Wireless to continue to provide the most reliable wireless network to the citizens and businesses of Pendergrass and Dawson County. Thank you for your thoughtful consideration of this request.

Sincerely, Sher- Ali Julia

Sher Kalim

RF Design Engineer - Alpharetta, GA

Verizon Wireless

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133432 Juno	Juno	60 ROCK CELLAR RD	Dawsonville GA		30534 DAWSON	9/1/1997	34.49972222	-84.22	1016200	1016200 Crown Castle	Self Support (Lattice Tower)
133972	133972 Dawsonville	LAND LOT 53 BUDDY BURT RD Dawsonville GA	Dawsonville GA		30534 DAWSON	3/1/2000	3/1/2000 34.40055556 -84.10972222	-84.10972222	1019720	1019720 Crown Castle	Guyed structure
133985	133985 Premium Outlets	168 SWEETGUM RD	Dawsonville GA		30534 DAWSON	4/17/2003	4/17/2003 34.36472222	-84.03		SBA	Monopole
158548	158548 Chestatee	3829 HIGHWAY 400 NORTH	Dawsonville GA		30534 DAWSON	1/28/2005	34.40722222	-84.00222222	1230411	1230411 Crown Castle	Monopole
160109	160109 BIG CANOE	6086 Monument Road	Jasper GA		30143 PICKENS	8/29/2007	8/29/2007 34.48555556 -84.33138889	-84.33138889		Land Owner	Self Support (Lattice Tower)
161016	161016 AMICALOLA	352 HIGH SHOALS RD	Dawsonville GA		30534 DAWSON	10/30/2006	10/30/2006 34.57222222 -84.23861111	-84.23861111		Crown Castle	Self Support (Lattice Tower)
191691	191691 Kincaid	292 HARLET FAUCETT RD	Dawsonville GA		30534 DAWSON	6/25/2013	6/25/2013 34.53694444 -84.26755556	-84.26755556		American Tower/VERIZON Monopole	Monopole
260882 Nix	Nix	6174 Dawsonville Highway	Dawsonville GA		30534 FORSYTH	8/28/2017	34.32181111	8/28/2017 34.32181111 -84.00417778	1250957 SBA	SBA	Monopole
266451	266451 Carlisle	338 Carlisle Road	Dawsonville GA	3053	30534 DAWSON	12/10/2013	12/10/2013 34.34472222	-84.04583333		Crown Castle	Monopole
287944	287944 JOEY - Caine	82 Goodson Road	Dawsonville GA		30534 DAWSON	9/30/2019	34.347481	-84.108525		American Tower/VERIZON Monopole	Monopole
418213 RUBY	RUBY	790 Eagle Perch Rd	Ball Ground GA	3010	30107 PICKENS	3/28/2018	34.388056	-84.271111		Mid-American Tower	Self Support (Lattice Tower)
435930	PUMPKIN PATCH - D	435930 PUMPKIN PATCH - D 234 Van Ingram Road	Dawsonville GA		30534 DAWSON	6/2/2020	34,438333	-84.126667	1008132	1008132 Crown Castle	Guyed structure



October 8, 2021

Ms. Harmony Gee
Dawson County, Planning and Development Zoning Administrator
25 Justice Way, Suite 2322
Dawsonville, GA 30534

RE: Application for Special Use Permit

Proposed Tower Location: Near intersection of Wesley Chapel Rd and GA HWY 52,

Dawsonville, GA 30534

(Tower) Parcel ID: 049 001 (Zoned RA/ 58.99 acres)

Ms. Gee,

In order to improve coverage and capacity issues due to increased wireless congestion, Verizon Wireless requires a new cell site in Dawson County, GA. Upon concluding there are no available suitable structures in the area upon which to co-locate, the only option is to build a new telecommunication tower. Verizon Wireless wishes to construct the new tower and will also lease antenna space on the structure and necessary ground space to other wireless providers.

Enclosed please find Verizon Wireless' application for a Special Use Permit along with supporting documentation for the construction of a wireless telecommunication facility on Parcel 049 001, located at the intersection of Wesley Chapel Rd and GA HWY 52, Dawsonville, 30534, Dawson County, Georgia. The property is owned by Joyce Hutcheson.

The proposed tower will be a one hundred ninety-foot (190') monopole with a five-foot (5') lightning rod at its top for a total height of one hundred and ninety-five feet (195'). Per the County ordinance and EIA/TIA code, the tower will be designed for at least three (3) additional tenants.

Upon the completion of construction, the facility will be unmanned, visited on average once per month for routine maintenance purposes, and will not emit noise or glare. It will be constructed and maintained in compliance with all federal, state, and local building codes and standards.

The proposed site will be compliant with Enhanced 911, a federally mandated program to improve the reliability of E911 service to the surrounding area and citizens of Dawson County, GA.

The following information also is provided in support of the Application for the proposed Telecommunication Facility:



- Wireless telecommunication facility and antennas will be located, fenced, or otherwise secured in a manner that prevents unauthorized access. The intended fencing is shown on the enclosed Construction Drawings.
- 2. The facility will not constitute a safety or health hazard, a nuisance, or have a noxious effect on the surrounding area either due to appearance and/or operations.
- 3. The facility will have a sign at the site to provide adequate notification to persons in the immediate area of the presence of an antenna that has transmission capabilities. No other signage, including advertising, will be allowed on any facilities, antennas, antenna supporting structures or antenna towers, unless required by law.
- 4. The antennas to be installed on the tower will be in compliance with current Federal Communications Commission standards.
- 5. The proposed telecommunication facility will be in compliance with all applicable Federal Aviation Administration regulations.
- 6. The proposed telecommunication facility will not post a hazard to health, safety, public welfare or the environment of the County or its residents.

In support of the proposed telecommunication facility, find the following items:

- Exhibit 1. Deed.
- Exhibit 2. Survey.
- Exhibit 3. Construction Drawings contain a site plan to scale specifying the proposed location and dimensions of tower, access, parking, fences, landscape plans, existing and adjacent land uses.
- Exhibit 4. FAA Air-Space Study showing Determination of No Hazard.
- Exhibit 5. RF justification Letter with inventory of sites.
- Exhibit 6. RF Propagation/Coverage Maps supporting need of location.
- Exhibit 7. FCC Antenna Site Registration Search results.



In order to maintain a level playing field with its competitors also offering similar services, Verizon Wireless needs the proposed tower, at the proposed location, at the proposed height, and at the requested signal levels, to deliver a consistently reliable signal in this geographic area.

Respectfully submitted,

Greg Spence

Greg Spence

Chief Executive Officer

Fortified Telecom Services, Inc.

Consultant, Verizon Wireless



Section 410. Telecommunication Towers and Antennas

A. General Requirements.

- 1. **Principal or Accessory Use.** A tower and/or antenna is considered a principal use if located on any lot or parcel of land as the sole or primary structure, and is considered an accessory use if located on a lot or parcel shared with a different existing primary use or existing structure. An existing use or structure on the same lot or parcel shall not preclude the installation of an antenna or tower. For purposes of determining whether the installation of a tower or antenna complies with zoning district requirements, including but not limited to set-back, buffer, and other requirements, the dimensions of an entire lot or parcel shall control, even though the antenna or tower may be located on a leased area within such lot or parcel. Towers that are constructed and antennas that are installed, in accordance with the provisions of this ordinance shall not be deemed to constitute the expansion of a non-conforming use or structure. Accessory structures to the tower are for that of the facility only, no offices, vehicles or material storage is allowed in structure. Tower will be principal use as currently no structures existing on the parcel.
- 2. Inventory of Existing Sites. To facilitate the co-location of antennas, each applicant seeking to locate a new tower, alternative tower structure or antenna, or to modify any such existing structure, shall provide to the Department of Planning and Development an inventory of applicant's existing towers or alternative tower structures. Applicants seeking to erect an amateur radio tower or antenna as defined by Federal Communications Commission (FCC) regulations shall be exempt from this provision. The inventory shall include all such structures that are within the jurisdiction of the governing authority; within a municipality located, in whole or in part, within Dawson County; and within a one mile border of Dawson County, and shall include specific information about the location (latitude and longitude coordinates), height, design, tower type and general suitability for antenna colocation of each tower, and other pertinent information as may be required by the Department of Planning and Development. The Department of Planning and Development may share such information with other applicants for a Communication Tower permit under this Ordinance or other organizations seeking to locate towers or antennas within the jurisdiction of the governing authority, provided, however that the Department of Planning and Development is not, by sharing such information, in any way representing or warranting that such sites are available or suitable.

Tower Inventory is attached as Exhibit 5 to application.

B. Application Requirements.

1. Each special use application shall include a scaled site plan with topographical information, an elevation view, and other supporting drawings,



calculations and documentation.

Contained in Exhibit 3, Construction Drawings.

- The site plan must include setbacks, drives, parking, fencing, landscaping, adjacent uses, also the distances to all structures within 1000 feet, and any other information necessary to review the request.
 Contained in Exhibit 3, Construction Drawings.
- Documentation of radio frequency range, coverage area, and tower height requirements.

RF Propagation projections (Exhibit 6) and RF Support letter (Exhibit 5) have been submitted with this application.

- 4. Documentation of all hazardous and / or flammable materials that may be located on site, their quantity and method of storage.
- Location and height of all existing towers owned by the applicant inside of and within one mile of the boundary of Dawson County.
 Exhibit 5, RF support letter contains the inventory.
- 6. New freestanding communication towers and communication antennas shall not be allowed unless the applicant makes an affirmative showing based on competent substantial evidence that:
 - Existing towers and buildings do not technologically afford the applicant the ability to provide service to the service area of the applicant or service provider, and
 - b. The geographical boundaries of the proposed service area cannot technologically be bifurcated to avoid the necessity for a freestanding tower/antenna, and
 - c. There exists a present demand and formal commitment by a minimum of one wireless provider (may be that of the applicant) to locate at the proposed site.

Exhibit 6, RF propagation supports the case for the new tower.

- 7. All wireless telecommunications applications that are located on rooftops, water tanks must be able to adhere to the following aesthetic criteria:
 - a. Camouflage radome material
 - b. Paintable
 - c. Dual Polarized Antenna if camouflage and painting is unavailable.
 - d. No roof top MW dish may exceed 4 feet in diameter.



- e. Antennae placed on rooftops should be setback from the roof edge at a 1:1 ratio to the height of the antenna.
- 8. A balloon test is also required to be performed. Provide the date and time of the testing on the application and the applicant is further required to notify adjoining property owners of same.
 - Applicant acknowledges requirement and will notify the parcel owners and Dawson County of the time and date of balloon test two weeks prior to the 1st public hearing date.
- 9. If the telecommunications tower is federally funded, licensed or permitted a Section 106 Review is required pursuant to the National Historic Preservation Act to establish the effect, if any, on historic resources.

C. Zoning Requirements.

Communication towers and communication antennas are considered special uses and upon proper application and approval may be permitted in the following zoning categories:

- 1. C-CB
- 2. C-HB
- 3. C-PCD
- 4. C-IR
- 5. R-A, if proposed to be located on a single lot or parcel of not less than 5 acres
- 6. C-RB
- 7. CT, if zoned prior to May 1, 2010.

Special use status shall be revoked if not used within one year of approval.

D. Performance and Construction Standards.

- Structural Design. New Communication towers/antennas and modifications to existing structures including, without limitation, the addition of height, antennas or providers shall be constructed in accordance with all applicable County Building Codes and shall meet or exceed current standards and regulations of all applicable Federal, State and Local authorities. Lattice tower structures, self-supporting or guyed structures are prohibited.
- 2. Setbacks. Communication tower/antenna setbacks shall be measured from the base of the tower/antenna or protruding building structure at the base of the tower, whichever is closest to the property line, to the property line of the parcel on which it is located. Communication towers/antennas and their accessory structures shall comply with the minimum lot and setback requirements of the district in which they are located. In cases where there is a conflict between the minimum lot setback and street setback requirements, the greater setback shall apply. Guy wires and



support anchors are required to meet setbacks; they shall not extend outside of the property line and must be contained within the fenced area of the tower site. Exhibit 3, Construction drawings display setbacks. Tower is set back greater than its height (195ft) from the right of way and all property lines.

- 3. **Separation from Residential Uses.** Separation requirements for communication towers from residentially zoned lands, as outlined in Article III of this resolution except those lands zoned R-A, or residential uses shall be a minimum of 195 linear feet. Communication tower separation shall be measured from the base of the tower to the closest point of off- site uses.
 - Exhibit 3, Construction drawings display setbacks. Tower is set back greater than its height (195ft) from the right of way and all property lines.
- 4. **Separation Distances between Communication Towers.** Separation distances between communication towers shall be applicable for and measured between the proposed tower and those towers that are existing and/or have received land use or building permit approval from the County. The separation distances shall be measured by drawing or following a straight line from the base of the existing tower to the base of proposed tower, pursuant to a site plan, of the proposed tower. Minimum separation distances (listed in linear feet) shall be as follows:

Applicant will include a Variance request as tower will be approximately 15,620ft from the nearest tower.

SEPARATION REQUIREMENTS BY TOWER TYPES

PROPOSED TOWER TYPES	Lattice, Self- Supporting or Guyed	Monopole 75' in Height or Greater	Monopole Less Than 75' in Height
Camouflaged or Monopole 75' in Height or Greater	15,840 feet	15,840 feet	10,560 feet
Camouflaged or Monopole Less than 75' in Height	10,560 feet	10,560 feet	10,560 feet

- 5. **Fencing.** A chain link fence or wall not less than six (6) feet in height, from finished grade equipped with an appropriate anti-climbing device shall be provided around each communication tower. Access to the tower shall be through a locked gate.
 - Exhibit 3, Construction drawings, page C-11.
- 6. Landscaping. Landscaping shall mitigate the visual impacts of a communication tower. Where adequate vegetation is not present, tower facilities shall be landscaped with a landscape buffer that effectively screens the view of the tower compound. The use of existing vegetation shall be preserved to the maximum extent practicable and may be used as a substitute for or in



supplement towards meeting landscaping requirements.

Seeking exemption from Landscaping requirements due to proposed tower location being situated in the woods. With the stipulation that if the location is ever deemed 'visible' by Planning and Zoning, Landscaping will be added to the site.

- a. Landscape buffers shall be a minimum of ten (10) feet in width and located outside the fenced perimeter of the tower compound; and
- b. A row of trees a minimum of eight (8) feet tall (planted height) and a maximum of twenty (20) feet apart shall be planted around the perimeter of the fence; and
- c. A continuous hedge at least thirty (30) inches high at planting and capable of growing to at least thirty-six (36) inches in height within eighteen (18) months shall be planted in front of the tree line referenced above; and
- d. All landscaping shall be of the evergreen variety and conform with landscape standards to be approved by Planning & Development Office at the time of permitting.
- e. If existing foliage is to be used as buffer, it must be labeled and incorporated into site plan and approved through Planning & Development Office.
- f. Upon final installation of new trees, shrubs or other landscape material planted to meet the requirements of this section and prior to receipt of a Certificate of Occupancy, the owner shall either provide proof of warranty or post a Maintenance Bond or other acceptable surety, warranting the new material for a period of no less than one (1) year. The bond shall be posted in an amount equal to 20% of the actual cost of the material and installation.
- g. The department shall perform an inspection of the plantings and landscape materials required by these regulations prior to the expiration of the one (1) year warranty or maintenance period. The tower owner shall be notified of any replacements or restoration that must be made to maintain compliance with these regulations.

Required landscape materials found to be dead or near death shall be replaced prior to release by the Department of the warranty or maintenance surety. In no case shall replacement be delayed more than thirty (30) days from notification, unless a performance bond is posted with the Department. Such performance shall be completed within six (6) months of posting. Exhibit 3, Construction drawings, page L-1.

7. **Height.** No freestanding communication tower/antenna shall exceed 195 feet in height from ground level. Where installed on top of a building, no communication tower/antenna shall extend greater than 20% over the building



height. An existing communication tower may be modified to a taller height not to exceed 20 feet over the tower's existing height, NEVER to exceed the maximum height of 195 ft., to accommodate the co-location of an additional communication antenna(s).

- a. The height change referred to in this subsection may only occur one time per communication tower.
- b. The additional height referred to in this subsection shall not require an additional distance separation. The communication tower pre-modification height shall be used to calculate such distance separations.

Tower is 195Ft tall inclusive of appurtenances.

8. **Illumination.** Communication towers/antennas shall not be artificially lighted.

Tower will not be illuminated.

- 9. Co-location. Proposed communication antennas may and are encouraged to co-locate onto existing communication towers, provided such co-location is accomplished in a manner consistent with zoning and performance standards, new or additional special use approval is not required. If it is determined by the County that the proposed tower is situated in a location which will benefit the County's telecommunication systems, then the tower shall be engineered and constructed to accommodate the additional telecommunication equipment beneficial to the public system at a cost to the County no greater than the actual expense of the provider in so engineering and constructing the tower to meet the County's needs.
 - a. Monopole communication towers shall be engineered and constructed to accommodate a minimum of three additional communication service providers.
 - Exhibit 3, Construction drawings, pages C-3, C-5 and C-7.
 - b. Camouflaged communication towers may be engineered and constructed without accommodating additional communication service providers.
 - c. Communication towers located within electrical substations may be engineered and constructed without accommodating additional communication service providers. Such towers shall be monopole construction and shall be subject to all of the requirements of Article II, Communication Tower and Communication Antenna Permits and Regulations.
- E. **Noninterference.** No communication tower or antenna shall interfere with public safety communication. Frequency coordination is required to ensure noninterference with public safety system and/or public safety entities.



Applicant acknowledges this requirement.

- F. **Variances.** Any request to deviate from any of the requirements of this section shallrequire approval of the Planning Commission.
- G. Abandonment. Without waiving the County's right to determine whether or not a communication tower has been abandoned, it shall be the duty of the tower owner to notify the County in writing of any intent to abandon use of the tower. Said notice shall include steps that tower owner shall take to accomplish removal of the tower structures. In the event the use of any communication tower has been discontinued for a period of 180 consecutive days, the tower shall be deemed to have been abandoned. Upon such abandonment, the owner/operator of the tower shall have an additional 45 days within which to: (1) reactivate the use of the tower or transfer the tower to another owner/operator who makes actual use of the tower; or (2) dismantle and remove the tower. The Owner of the tower shall be ultimately responsible for all costs of dismantling and removal and in the event the tower is not removed within 45 days of abandonment, the County may proceed to do so and assess the costs against the tower owner. The lien of such assessment shall bear interest, have priority and be collectable at the same rate and in the like manner as provided for by Georgia law. At the earlier of 46 days from the date of abandonment without reactivation or upon completion of dismantling and removal, any special use permit, waiver and/or variance approval for the tower shall automatically expire. Applicant acknowledges this requirement.
- H. **Finished Color.** Communication towers not requiring FAA painting/marking shall have either galvanized finish or be painted with a non-reflective paint in a non-contrasting blue, gray or black finish. The color should be selected so as to minimize the equipment's visibility.

Tower will be manufactured from galvanized steel.

- I. **Maintenance.** To ensure the structural integrity of towers, the owner of a tower shall be maintained in compliance with standards contained in applicable standards for towers that are published by the Electronic Industries Association, as amended from time to time. If, upon inspection, the governing authority concludes that a tower fails to comply with such codes and standards and constitutes a danger to persons or property, then upon notice being provided to the owner of the tower, the owner shall have thirty (30) days to bring such tower into compliance within such standards. If the owner fails to bring such tower into compliance within said thirty (30) days, the governing authority may remove such tower at the owners' expense. Any such removal by the governing authority shall be in that manner provided in Sections 41-2-8 through 41-2-17 of the Official Code of Georgia.
- J. **Liability Insurance.** Liability insurance in an amount not less than \$1,000,000 shall be maintained by the owner and operator of the facility until such facility is dismantled and removed from the parent site. Failure to maintain insurance coverage shall constitute a violation of this Code and grounds for revocation of special use approval.



Proof of same shall be supplied to the Department of Planning and Development upon application for permit.

K. Fees.

- 1. The fees for special use approval for a communication tower/antenna shall be \$2,500 inclusive of the third party review cost.
- 2. The development plan review fees shall be the same as for any commercial development.
- 3. The building permit fees shall be set at \$500.00 and shall cover the tower and associated equipment building. Any other permits required shall be charged at the prescribed rate at the time of development or construction.
- 4. As with any special use application, the applicant shall be required to submit fee amounts as deemed sufficient and appropriate by the County in order to obtain any needed technological expertise so as to assist County staff in evaluation the request. In order to receive an objective, qualified verification of the application submitted requesting the approval of a special use permit for a communication tower / antenna, an independent RF consulting company, chosen by Dawson County, will evaluate such application. The independent consulting company will evaluate all RF applications on the merits of the applicant's ability to meet or exceed the standards of this article. The fee to secure a third party review shall be inclusive in the special use request fee paid by the applicant at the time of filing for a special use permit with the County. Information to be provided to the independent consultant for review and evaluation is as follows:
 - a. No new telecommunications structure may be constructed without providing the following information:
 - 1. Propagation map of Existing Coverage (scale) on Paper and Proposed Coverage (scale) on Clear Film with RSSI (Received Signal Strength Indicator) or Eb/lo values distinguished by different color criteria.
 - 2. Latitude/Longitude (NAD 27), Ground Elevation AMSL, Antenna Radiation Center, ERP (watts) out of the antenna, Antenna Manufacturer, Antenna model, Antenna Beam width, Antenna Tilt, Antenna Gain and Antenna Pattern.
 - 3. Name of Propagation Tool, Propagation Parameters specifications.
 - 4. Frequency TX Band / RX Band, License Block.
 - 5. Inventory of applicant's existing sites within a 5-mile radius.
 - 6. Name, Number and title of submitting engineer.



[Note: If propagation parameters are not submitted then a test transmitter drive shall be conducted after test procedures and hardware are pre-approved and verified on site by the Independent Consulting Company.]

- b. No new telecommunications structure may be constructed if proof of the following can be made:
 - 1. 80% of the proposed coverage area can be accomplished by an existing structure or alternate means of transmission (i.e. repeater, carrier system modification).
 - 2. Proposed Telecommunications site exceeds FCC RF emissions Power Density standard of 1 mw/cm² for uncontrolled environments.
- 3. Telecommunication site does not meet FAA/FCC rules and Regulations.
- 4. A previously approved site application will meet the current applicant's coverage or capacity objectives.
- c. Any approved wireless telecommunication tower must adhere to the following conditions:
 - Proof of FAA 'No hazard determination assessment' or 'No notice of construction needed'. If a notice of construction is required, the FAA can only grant the 'No Hazard of Determination Assessment'. Only an Aviation consultant once coordinated with the Independent Consultant can determine if a No notice of Construction is warranted if and only if the tower is greater than 5 miles from an airport or 2 miles from a Heliport. Exhibit 3, FAA Determination of No Hazard.
 - 2. Update of ERP (watts) per site, per sector upon filing for new cell tower.
 - 3. Update of antenna type, antenna beam width, antenna gain, antenna tilt, and Radiation Center upon filing for new cell tower.
- L. **Variance**. Any request for variance from the provisions of this article shall be presented directly to the Dawson County Planning Commission per Article IX of this resolution.
 - A variance application is being submitted in conjunction with the Special Use Permit application.
- M. **Violation**. Any person violating the provisions of these regulations shall be guilty of violating a duly adopted Ordinance of Dawson County, and upon conviction by a court of competent jurisdiction may be penalized pursuant to Section 1206 of the Land Use Resolution.



No additional information	on

Printed: 10/7/2021 12:18:10 AM



Official Tax Receipt **Dawson County** 25 Justice Way, Suite 1222 Dawsonville, GA 30534 --Online Receipt--

Trans No	Property ID / District Description	Original Due	Interest & Penalty	Amount Due	Amount Paid
2020 - 7188	049 001 001 / 1 L 559-60 596-598 628-9 LD 5 FMV: 10900	\$103.16	\$0.00 Fees: \$0.00 \$0.00	\$0.00	\$103.16
	Totals:	\$103.16	\$0.00	\$0.00	\$103.16

Transaction Balance	
\$0.00	
\$0.00	

Phone: (706) 344-3520

Fax: (706) 344-3522

Paid Date: 11/17/2020 Charge Amount: \$103.16



Scan this code with your mobile phone to view this bill



2020 Property Tax Statement


Nicole Stewart

25 Justice Way, Suite 1222 Dawsonville, Georgia 30534

Office: 706--344-3520 | Tax Assessors: 706-344-3590

					0111001100					
PROPERTY OWNER(S)	MAP C	ODE	LOCATIO	ON	BILL#		DISTRIC	DISTRICT		
HUTCHESON JOYCE	049 00	01	WESLEY CHA	PEL RD	2020-7187		1			
	BUILDING VALUE	LAND VALUE	TOTAL FAIR MARKET VALUE	ACR	ES E	XEMPTIONS	DUE	DATE		
	0	229,500	229,500	58.	99	SV	12/1	/2020		
		PROPERTY DESCRIPTION:								
		L 559-60 596-598 628-9 LD 5								
	TOTAL FAIR MARKET VALUE	40% ASSESSED VALUE	LESS EXEMPTIONS	TAXABLE VALUE	MILLAGE RATE	GROSS TAX	LESS CREDITS	NET TAX		
STATE TAX	229,500.00	91,800.0	73,284.00	18,516.00) (0	0	0		
COUNTY M&O	229,500.00	91,800.0	73,284.00	18,516.00	12.377	229.17	0	146		
SALES TAX ROLLBACK	0.00	0.0	0.00	18,516.00	-4.492	! 0	-83.17	0		
SCHOOL M&O	229,500.00	91,800.0	73,284.00	18,516.00	15.778	292.15	0	292.15		
TOTAL					23.66	521.32	-83.17	438.15		

Please note that your Tax Commissioner is responsible for the billing and collection of tax and is not responsible for the property value or the millage rates which are used to determine the tax amount due.

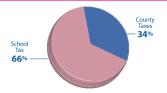

THE PIE GRAPH SHOWS HOW THE AVERAGE TAX DOLLAR IS DISTRIBUTED AMONG THE VARIOUS GOVERNMENT AGENCIES. (PERCENTAGES MAY VARY DEPENDING ON EXEMPTIONS)



2020 Current Due	438.15
Penalty	0.00
Interest	0.00
Other Fees	0.00
Previous Payments	438.15
Delinquent Tax*	0.00
TOTAL DUE	0.00

^{*} Please note that delinquent tax due reflects total owed at the time of billing and the amount will change monthly due to interest charges. Please read the state mandated penalties and interest on the back of this bill.

DETACH TOP PORTION TO KEEP FOR YOUR RECORDS AND RETURN BOTTOM PORTION WITH PAYMENT.

Make payable to "Dawson County Tax Office" and include this coupon. Do not staple, tape or attach payment.

DAWSON COUNTY, GEORGIA 2020 TAX BILL

25 Justice Way, Suite 1222 Dawsonville, Georgia 30534



LEGAL DESCRIPTION	MAP ID#	TAX BILL #		
L 559-60 596-598 628-9 LD 5	049 001	2020-7187		

TOTAL DUE December 1, 2020
Late fees, interest, and penalties will apply to the unpaid balance at midnight on December 1, 2020.

\$ 0.00

PLEASE WRITE THE MAP ID# ABOVE ON YOUR CHECK

If receipt is desired, please include a self-addressed stamped envelope or print at www.DawsonCountyTax.com. If delinquent taxes are due, please call 706-344-3520 for current amount as interest continues to accrue.

HUTCHESON JOYCE

Nicole Stewart
TAX COMMISSIONER

25 Justice Way, Suite 1222 Dawsonville, Georgia 30534-3454

Thank you for the privilege of serving as your Tax Commissioner ... \icole Stewart

Dawson County Courthouse 25 Justice Way, Suite 1222 • Dawsonville, GA 30534 Phone: 706-344-3520. Monday – Friday 8am to 5pm

UNDERSTANDING MY TAX BILL

MILLAGE RATE

The millage rate (also known as the tax rate) is a figure applied to the taxable value of your property to calculate your property tax liability. One "mill" equals one dollar of tax on every thousand dollars of taxable value. This rate is set by the Board of Commissioners and the Board of Education.

FAIR MARKET VALUE & ASSESSED VALUE

The fair market value of your property is determined by the Tax Assessors office. The assessed value is 40% of the fair market value.

STATE MANDATED PENALTIES AND INTEREST

If payment is late, the following interest and penalty will be added to the balance owed:

- Interest is applied monthly as prescribed by law.
- A five percent (5%) penalty will be added to the unpaid principle 120 days from the due date. An additional 5% penalty (on the unpaid principle) will accrue again every 120 days until a maximum of 20% of the original principle has been charged.

TAXES ESCROWED THROUGH MORTGAGE COMPANY

It is ultimately the responsibility of the property owner to ensure tax is paid. Please forward this tax bill to your mortgage company. **We do not send one to them.**

E-SERVICES

Sign-up at www.DawsonCountyTax.com for statement notifications and reminder e-alerts.

ADDRESS CHANGE

Please note that your tax bill has been mailed to the address in our records. Failure to receive a tax bill does not relieve obligation to pay tax bill by due date. It is the responsibility of the taxpayer to have a current and updated address on file with the Tax Assessors office. Please fill out below and return with your payment.

Name:		
New Address:		_
Taxpayer Signature:		
Map Code#:	Daytime Phone#:	

FOR YOUR CONVENIENCE

On December 1st, 2021 the Dawson County Tax Commissioner's Office will have extended hours until 6pm. This is to accommodate residents who are unable to make it to the office before 5pm.

APPEALED BILLS

Appealed bills are billed at 85%, unless requested at time of appeal application with the Tax Assessors Office to bill at 100%. After the appeal process is final, we will refund you for the amount due or rebill you for the remaining amount due.

ASSESSORS INFORMATION

All exemptions are applied for at the Tax Assessors office and approved by the Board of Assessors. For more information please call (706) 344-3590.

PROPERTY BOUGHT OR SOLD

Property taxes are not pro-rated according to sale date, amount of usage, or current ownership.

BUSINESS, BOATS & AIRCRAFT:

If you owned the property on Jan 1st of the tax bill year, you must pay the tax in full. In January, you will receive a Personal Property Reporting Form from the Tax Assessors office. Be sure to return this form with a signed Bill of Sale indicating what property was sold, the purchaser's name, address, and the date of sale. If you did not own the property on Jan 1st of the tax bill year, please contact the Tax Assessors immediately at (706) 344-3590.

REAL ESTATE:

The property tax statement is sent to the Jan 1st owner and the current owner, if known. If the tax liability is transferred to the new owner, please forward the signed settlement statement reflecting that transfer to the Tax Commissioner by mail or email tagoffice@dawsoncounty.org

PAYMENT OPTIONS

Online: <u>www.DawsonCountyTax.com</u> (American Express, Discover, MasterCard, Visa, PayPal and PayPal Credit)

In Person: Dawson County Courthouse 25 Justice Way, Suite

1222 Dawsonville, GA 30534 M-F 8am to 5pm

By Mail: Check mailed to Dawson County Tax Commissioner

25 Justice Way, Suite 1222 Dawsonville, GA 30534


By Phone: (706) 701-2576 - Enter your bill number without

the year. Example: Bill 2021-1234-enter 1234 ONLY.

Outdoor Drop Box: Located at the crosswalk at the entrance to the Dawson County Courthouse.

No payment contracts will be allowed.

\$35 fee for all returned checks.

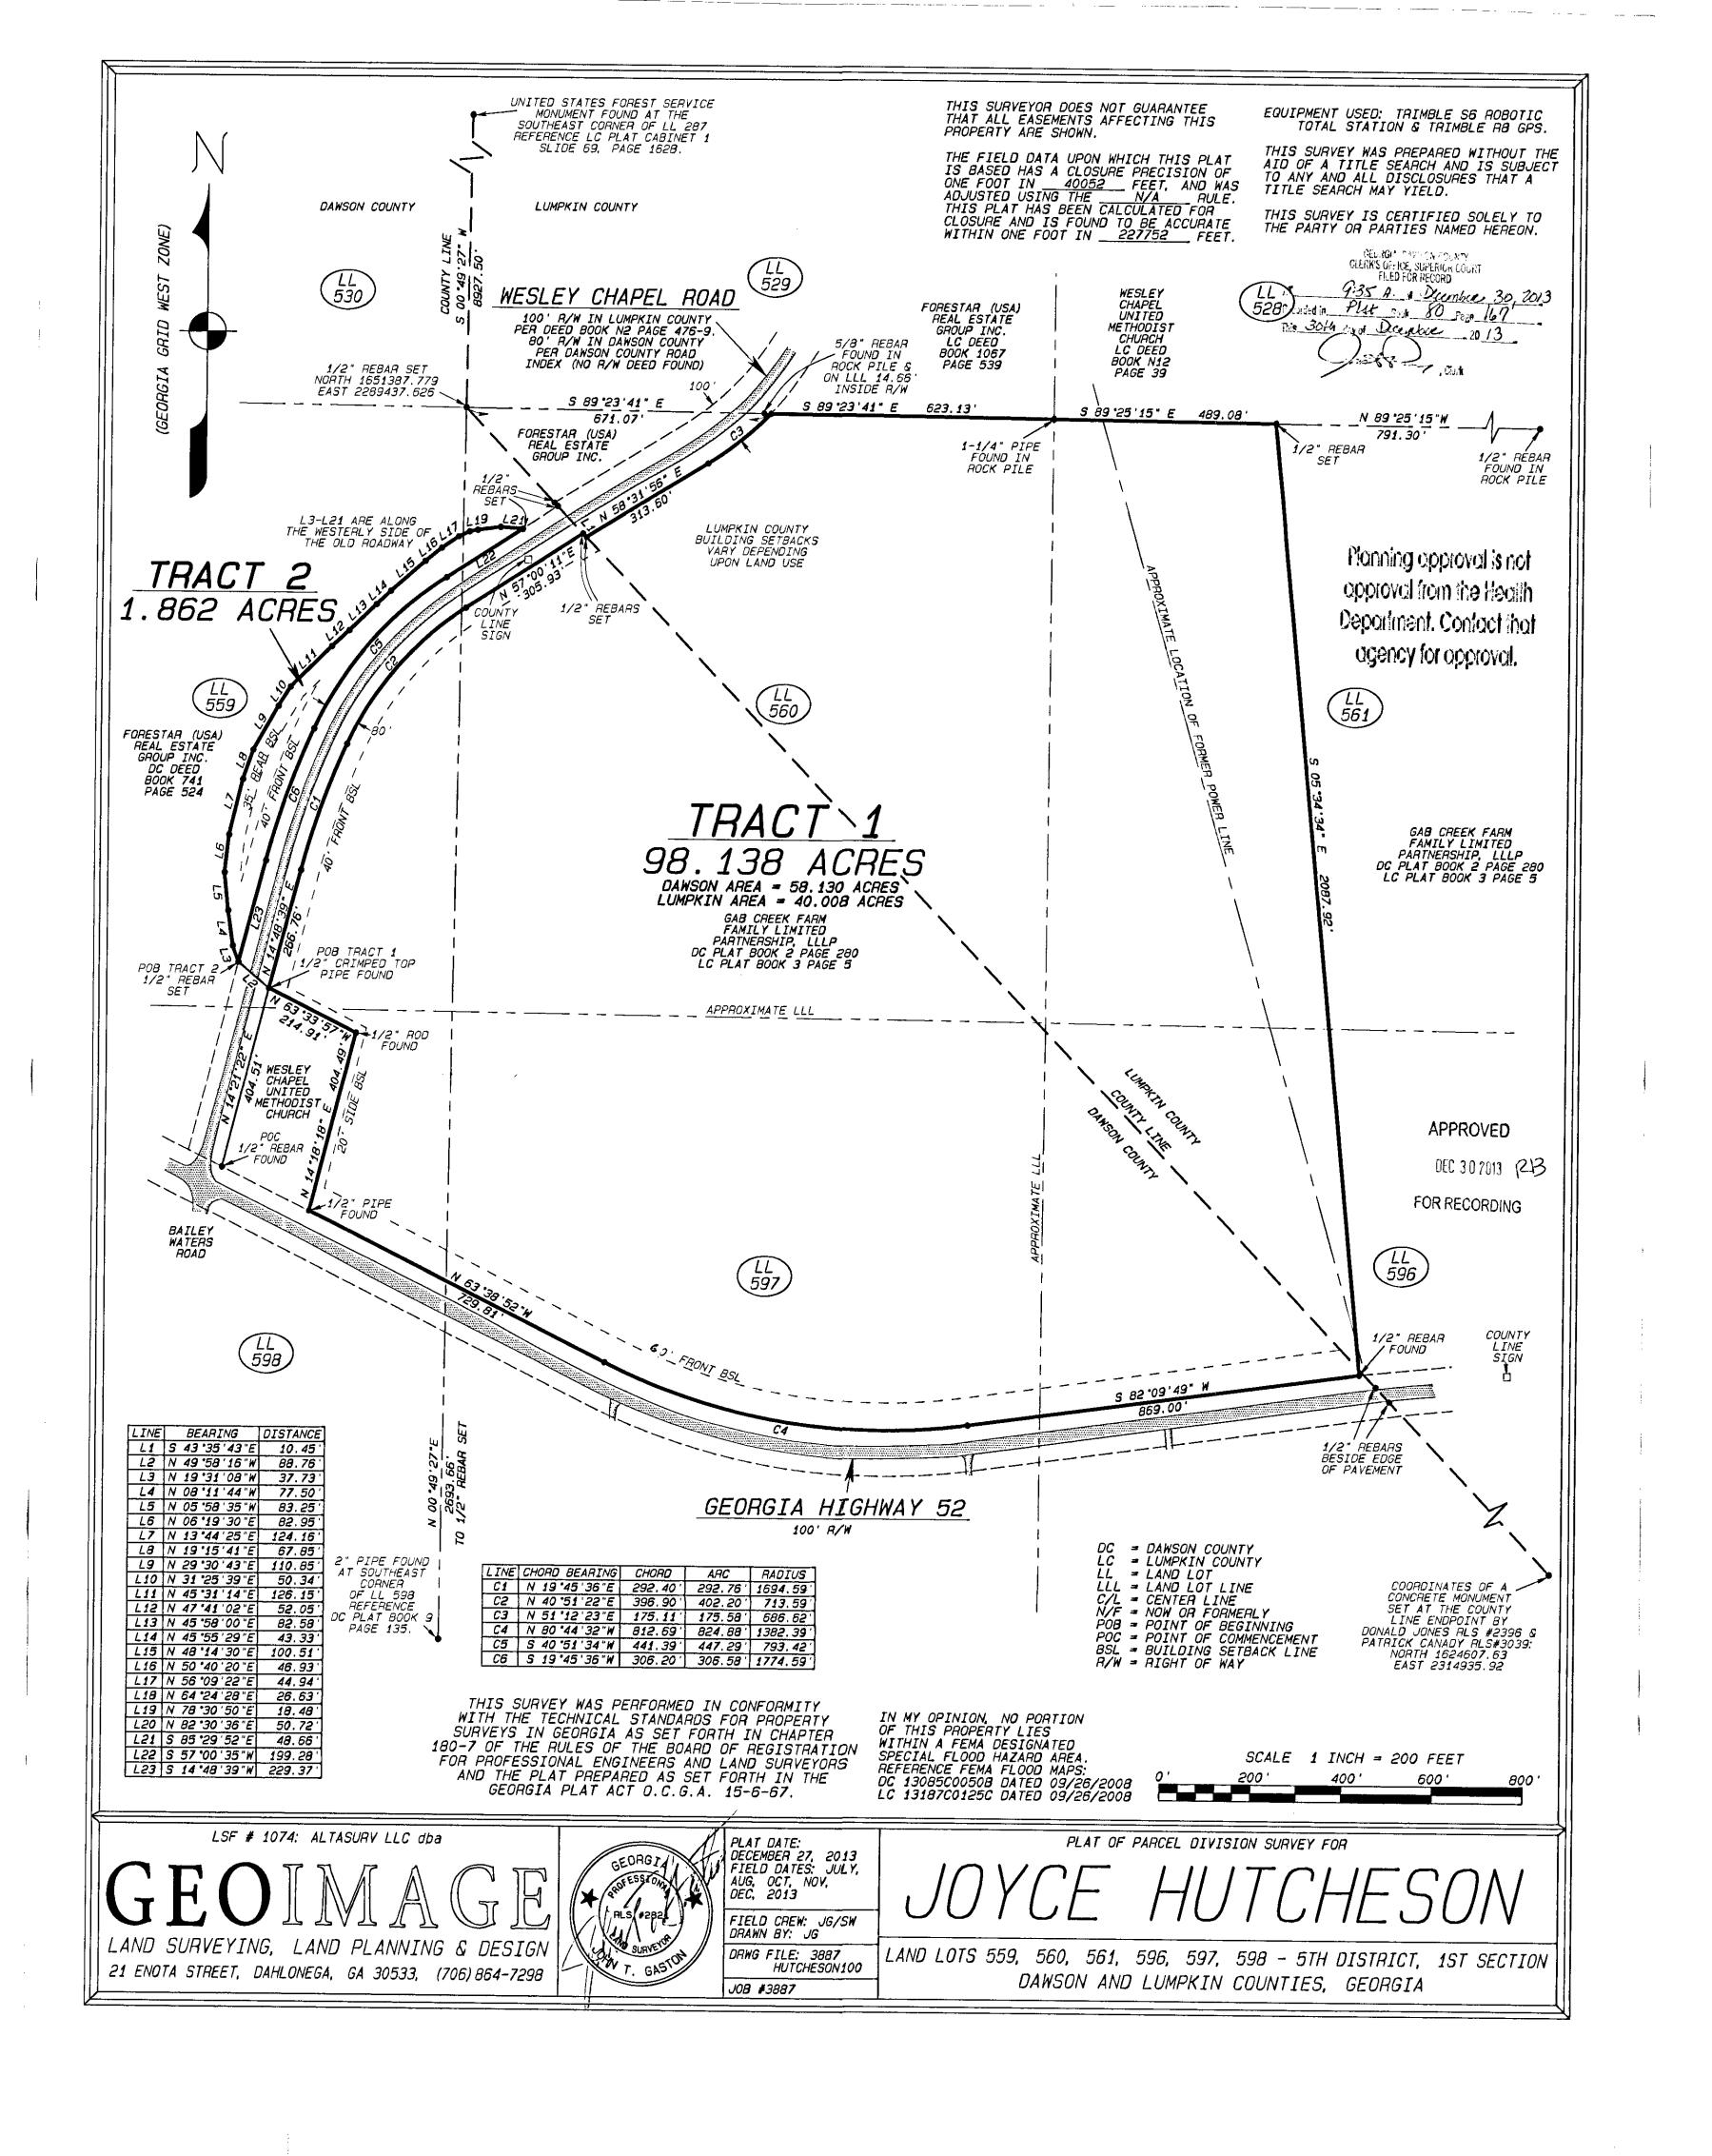



February 11, 2022

Sharon Farrell, Planning Director
Dawson County Planning & Development
25 Justice Way
Suite 2322
Dawsonville, Georgia 30534

VIA: E-Mail

RE: SU 21-07 / 3rd Party Review of Verizon's Special Use Application for a New Telecommunications Facility

Dear Ms. Farrell,

At your request, and on behalf of Dawson County ("County"), Georgia, Level-Up Companies, LLC. ("Level-Up"), as a Telecommunication consultant for the County, has considered the merits and data of the above referenced application submitted by Fortified Telecom Services, as consultant for Verizon Wireless to construct a new wireless telecommunications support structure and associated ground compound. The property is owner by Joyce S Hutcheson, Parcel ID# 049 001, near Wesley Chapel Rd. in Dawsonville, GA.

Pursuant to the Dawson County Code of Ordinances, SEC. 121-109.(o)(4) states that, "In order to receive an objective, qualified verification of the application submitted requesting the approval of a special use permit for a communication tower/antenna, an independent RF consulting company, chosen by Dawson County, will evaluate such application. The independent consulting company will evaluate all RF applications on the merits of the applicant's ability to meet or exceed the standards of this article...Information to be provided to the independent consultant for review and evaluation is as follows:". The enclosed "Schedule A" runs through all items to be reviewed by Level-Up.

A. <u>No new telecommunications structure may be constructed without</u> providing the following information:

 Propagation map of Existing Coverage (scale) on Paper and Proposed Coverage (scale) on Clear Film with RSSI (Received Signal Strength Indicator) or Eb/Io values distinguished by different color criteria.

Response: Submitted Document: Exhibit 6, page 7, 8, 9: After speaking with the Applicant, he was able to send me the revised Propagation Map/Exhibit 6 with some minor corrections. Attached/Enclosed is the updated Prop Maps. This document, specifically page 7, clearly illustrates a hole in reliable Verizon coverage that currently exists inside the target search area



distinguished by different color-coded criteria. Page 8 clearly illustrates what the coverage would look like with the proposed Telecommunication Facility with Verizon's antenna mounted at a centerline height of 185' above ground level (AGL). Page 9 clearly illustrates that the closest existing structure (that Verizon Wireless is not already operating from) would not come close to covering the intended targeted area. I believe the applicant has satisfied this requirement

2. Latitude/Longitude (NAD 27), Ground Elevation AMSL, Antenna Radiation Center, ERP (watts) out of the antenna, Antenna Manufacturer, Antenna model, Antenna Beam width, Antenna Tilt, Antenna Gain and Antenna Pattern.

Response: Submitted Document: Exhibit 3, & Exhibit 6; contain Lat/Long (N 34 32 05.514, W - 84 11 25.647); Exhibit 4 contains the Ground elevation of 1570' AMSL, Antenna RAD Center is shown in Exhibit 3 (page 10 of 26) which is 185', Exhibit 5 (page 2 of 3) mentions that ERPs are within the limitations specified by the commission's rules. I contacted the applicant, and he was able to supply the antenna manufacturer, model, specs. These are subject to change, depending on when VzW plans to build and install antennas on the tower. Therefore, it will be important to update of ERP (watts) per site, per sector upon filing for new cell tower – along with update of antenna type, antenna beam width, antenna gain, antenna tilt, and radiation center (pursuant to code 121-109.o.4c – also mentioned below).

Exhibit 5 also indicates (and I agree with): The FCC has established safety rules relating to potential RF exposure from cell sites. The rules are codified at 47 C.F.R § 1.1310. The FCC provides guidance on how to ensure compliance with its rules in the FCC Office of Engineering and Technology Bulletin 65, available at:

https://transition.fcc.gov/Bureaus/Engineering_Technology/Documents/bulletins/oet65/oet65.pdf

The FCC developed the RF standards, known as Maximum Permissible Exposure (MPE) limits, in consultation with numerous other federal agencies, including the Environmental Protection Agency, the Food and Drug Administration, and the Occupational Safety and Health Administration. The FCC provides information about the safety of radio frequency (RF) emissions from cell towers on its website at: https://www.fcc.gov/engineering-technology/electromagnetic-compatibility-division/radio-frequency-safety/faq/rf-safety.

3. Name of propagation tool, propagation parameters specifications.

Response: Atoll, calibrated for "Rural propagation" model. Atoll is a multi-technology wireless network design and optimization platform that supports wireless operators throughout the



network lifecycle, from initial design to densification and optimization. Atoll's integration and customization features help operators smoothly streamline planning and optimization processes.

4. Frequency TX Band/RX Band, License Block.

Response: The below chart was NOT submitted in the original package, but I was able to obtain

Callsign	Market	Radio Code	Market Number	Block	State	County	Licensee Name	Wholly Owned	Total MHZ	Freq Range 1	Freq Range 2	Freq Range 3	Freq Range 4	Regulatory Power
WQJQ690	Southeast	WU	REA002	с	GA	Dawson	Cellco Partnership	Yes	22.000	746.000- 757.000	776.000- 787.000	.000000	.000000	88.01
KNKN671	Georgia 2 - Dawson	CL	CMA372	A	GA	Dawson	Cellco Partnership	Yes	25.000	824.000- 835.000	869.000- 880.000	845.000- 846.500	890.000- 891.500	363.23
WQTX822	Gainesv , GA	cw	BTA160	с	GA	Dawson	Cellco Partnership	Yes	20.000	1895.000- 1905.000	1975.000 1985.000	.000000	.000000	454.72
WQVN943	Atlanta, GA-AL- NC	AT	BEA040	н	GA	Dawson	Cellco Partnership	Yes	10.000	1760.000 1765.000	2160.000- 2165.000	.000000	.000000	227.36
WQVN944	Atlanta, GA-AL- NC	AT	BEA040	ı	GA	Dawson	Cellco Partnership	Yes	10.000	1765.000 1770.000	2165.000 2170.000	.000000	.000000	227.36
WQGD537	Georgia 2 - Dawson	AW	CMA372	A	GA	Dawson	Cellco Partnership	Yes	20.000	1710.000 1720.000	2110.000 2120.000	.000000	.000000	170.52
WQGA934	Atlanta, GA-AL- NC	AW	BEA040	8	GA	Dawson	Cellco Partnership	Yes	20.000	1720.000 1730.000	2120.000- 2130.000	.000000	.000000	170.52

5. Inventory of applicant's existing sites within a five-mile radius.

Response: Exhibit 6, page 5 and 6 have been reviewed and satisfy this requirement

6. Name, number, and title of submitting engineer.

Response: Valery Pyram

Sr Engr Cslt-Radio Frequency Network System Performance

678 277 3535

10300 Old Alabama Connector Rd

Alpharetta, GA 30022



B. <u>No new telecommunications structure may be constructed if proof</u> of the following can be made:

1. Eighty percent of the proposed coverage area can be accomplished by an existing structure or alternate means of transmission (i.e. repeater, carrier system modification).

<u>Response:</u> Exhibit 6, page 9 clearly illustrates what coverage would look like if Verizon installed on the closest existing site, and it does not come close to helping achieve the goal for the search area in question. I'm satisfied that there is not an existing structure that would be able to be collocated upon as an alternate means to reach this specific RF goal.

 Proposed telecommunications site exceeds FCC RF emissions Power Density standard of 1 mw/cm (squared) for uncontrolled environments.

Response: There is nothing to indicate that this proposed site will exceed FCC RF Emissions Power Density standard.

3. Telecommunication site does not meet FAA/FCC rules and regulations.

<u>Response:</u> Based on the submitted documents, there is nothing I can see that would suggest that this site would not meet all FAA/FCC rules. Exhibit 4 documents that Notice to the FAA is not required

4. A previously approved site application will meet the current applicant's coverage or capacity objectives.

Response: Based on the documents submitted, I am not aware of a previously submitted application that will meet the applicant's coverage area



C. <u>Any approved wireless telecommunication tower must adhere to</u> the following conditions:

 Proof of FAA "No hazard determination assessment" or "No notice of construction needed". If a notice of construction is required, the FAA can only grant the "No Hazard of Determination Assessment". Only an aviation consultant once coordinated with the independent consultant can determine if a no notice of construction is warranted if and only if the tower is greater than five miles from an airport or two miles from a heliport.

Response: Exhibit 4 documents and clearly states that Notice the FAA is not required at the analyzed location

2. Update of ERP (watts) per site, per sector upon filing for new cell tower.

Response: As noted above regarding the equipment, according to the applicant, Greg Spence, Verizon does not yet know exactly when this site will be constructed, there is a chance that the equipment can change from now until then. Because of this, it is important to require Update of ERP (watts) per site, per sector upon filing for new cell tower.

- 3. Update of antenna type, antenna beam width, antenna gain, antenna tilt, and radiation center upon filing for new cell tower.
- 4. <u>Response</u>: As noted above regarding the equipment, according to the applicant, Greg Spence, Verizon does not yet know exactly when this site will be constructed, there is a chance that the equipment can change from now until then. Because of this, it is important to require Update of antenna type, antenna beam width, antenna gain, antenna tilt, and radiation center upon filing for new cell tower.



Summary:

In Summary, and to the best of my knowledge, all the information contained and included herein is accurate at the time of this report. All Opinions are unbiased, and recommendations are solely based on the technical merits absent of prejudice and following all prevailing laws and codes.

With this being said, it is of the opinion of Level-Up that this Special Use Application be approved.

Best Regards,

David Grigonis Level Up Companies <u>Dgrigonis@levelupcompanies.com</u> 410-365-5238

Schedule A





As with any special use application, the applicant shall be required to submit fee amounts as deemed sufficient and appropriate by the county in order to obtain any needed technological expertise so as to assist county staff in evaluation the request. In order to receive an objective, qualified verification of the application submitted requesting the approval of a special use permit for a communication tower/antenna, an independent RF consulting company, chosen by Dawson County, will evaluate such application. The independent consulting company will evaluate all RF applications on the merits of the applicant's ability to meet or exceed the standards of this article. The fee to secure a third party review shall be inclusive in the special use request fee paid by the applicant at the time of filing for a special use permit with the county. Information to be provided to the independent consultant for review and evaluation is as follows:

A. No new telecommunications structure may be constructed without providing the following information:								
,	Docum	entation						
	Submitted	Not Submitted	<u>Notes</u>					
Propagation map of Existing Coverage (scale) on Paper and Proposed Coverage (scale) on Clear Film with RSSI (Received Signal Strength Indicator) or Eb/lo values distinguished by different color criteria.	<u>x</u>		Submitted Document: Exhibit 6, page 7 & 8: Page 7 of exhibit 6 I believe shows the existing coverage distinguished by different color criteria, however I believe page 7 was tilted incorrectly, it's titled "Proposed LTE Coverage with HWY-52", I believe it should state "Existing Coverage with out HWY-52". After speaking with the Applicant, he was able to send me the revised Propagation Map/Exhibit 6 with the corrections (I will include with my submission of report). I believe the applicant has satisfied this requirement					
Latitude/Longitude (NAD 27), Ground Elevation AMSL, Antenna Radiation Center, ERP (watts) out of the antenna, Antenna Manufacturer, Antenna model, Antenna Beam width, Antenna Tilt, Antenna Gain and Antenna Pattern.	×		Submitted Document: Exhibit 3, & Exhibit 6; contain Lat/Long, Exhibit 4 contains the Ground elevation of 1570' AMSL, Antenna RAD Center is shown in Exhibit 3 (page 10 of 26), Exhibit 5 (page 2 of 3) mentions that ERPs are within the limitations specified by the commission's rules. I contacted the applicant and he was able to supply the antenna manufacturer, model, specs, gain and pattern. These are subject to change, depending on when V2W plans to actually build and install antennas on the tower. Exhibit 5 also indicates and I agree with: The FCC has established safety rules relating to potential RF exposure from cell sites. The rules are codified at 47 C.F.R § 1.1310. The FCC provides guidance on how to ensure compliance with its rules in the FCC Office of Engineering and Technology Bulletin 65, available at: https://transition.fcc.gov/Bureaus/Engineering_Technology/Documents/bulletins/oet65/oet65.pdf The FCC developed the RF standards, known as Maximum Permissible Exposure (MPE) limits, in consultation with numerous other federal agencies, including the Environmental Protection Agency, the Food and Drug Administration, and the Occupational Safety and Health Administration. The FCC provides information about the safety of radio frequency (RF) emissions from cell towers on its website at: https://www.fcc.gov/engineering-technology/electromagnetic-compatibility-division/radio-frequency-safety/faq/rf-safety.					
Name of propagation tool, propagation parameters specifications.	<u>x</u>		Atoll, calibrated for "Rural propagation" model. Atoll is a multi-technology wireless network design and optimization platform that supports wireless operators throughout the network lifecycle, from initial design to densification and optimization Atoll's integration and customization features help operators smoothly streamline planning and optimization processes.					
4. Frequency TX Band/RX Band, License Block.	<u>x</u>		I was able to track down all the Frequency and license information with the applicant, and will be included in my report.					
Inventory of applicant's existing sites within a five-mile radius.	<u>x</u>		Exhibit 6, page 5					
Name, number and title of submitting engineer.	<u>x</u>		Valery Pyram Sr Engr Cslt-Radio Frequency Network System Performance 0 678 277 3535 10300 Old Alabama Connector Rd Alpharetta, GA 30022					

B. No new telecommunications structure may be constructed if proof of the following can be made:									
	<u>Documentation</u>								
	Submitted	Not Submitted	Notes						
Eighty percent of the proposed coverage area can be accomplished by an existing structure or alternate means of transmission (i.e. repeater, carrier system modification).	<u>x</u>		Exhibit 6, page 9 clearly shows what coverage would look like if they did go on the closest existing available site, and it does not come close to helping achieve the goal for the search area in question						
Proposed telecommunications site exceeds FCC RF emissions Power Density standard of 1 mw/cm (squared) for uncontrolled environments.	N/A		There is nothing to indicate that this proposed site will exceed FCC RF Emissions Power Density standard.						
Telecommunication site does not meet FAA/FCC rules and regulations.	<u>x</u>		Based on the submitted documents, there is nothing I can see that would suggest that this site would not meet all FAA/FCC rules. Exhibit 4 documents that Notice to the FAA is not required						

 A previously approved site application will meet the current applicant's coverage or capacity objectives. 	N/A		Based on the documents submitted, I am not aware of a previously submitted application that will meet the applicant's coverage area
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C. Any approved wireless telecommunication tower must adhere to the following conditions:									
	<u>Documentation</u>								
	Submitted	Not Submitted	Notes						
Proof of FAA "No hazard determination assessment" or "No notice of construction needed". If a notice of construction is required, the FAA can only grant the "No Hazard of Determination Assessment". Only an aviation consultant once coordinated with the independent consultant can determine if a no notice of construction is warranted if and only if the tower is greater than five miles from an airport or two miles from a heliport.	<u>x</u>		Exhibit 4 documents and clearly states that Notice the FAA is not required at the analyzed location						
Update of ERP (watts) per site, per sector upon filing for new cell tower.	N/A		_						
Update of antenna type, antenna beam width, antenna gain, antenna tilt, and radiation center upon filing for new cell tower.	N/A		_						

Review Completed by: David Grigonis, Level-Up Companies
Date: 2/8/2022